

COMcheck Software Version 3.9.2
Envelope Compliance Certificate

90.1 (2007) Standard

Section 1: Project Information

Project Type: New Construction
Project Title: Denimier Outskane
Construction Site: _____
Owner/Agent: _____
Designer/Contractor: _____

Section 2: General Information

Building Location (for weather data): Wayne, Michigan
Climate Zone: 5a
Building Space Conditioning Type(s): Nonresidential
Vertical Stairing / Wall Area Pct: 44%
Building Type: Floor Area
Autonomous Facility: 9413

Section 3: Envelope Assemblies

Climate-Specific Requirements:

Table with 5 columns: Component Name/Description, Gross Area or R-Value, Cont. R-Value, Proposed U-Factor, Budget U-Factor. Lists various envelope components like exterior walls, doors, windows, and roof assemblies with their respective values.

Section 4: Compliance Statement

Compliance Statement: The proposed envelope design represented in this document is consistent with the building plans, specifications and other calculations submitted with this permit application. The proposed envelope system has been designed to meet the 90.1 (2007) Standard requirements in COMcheck Version 3.9.2 and to comply with the mandatory requirements in the Measurement Checklist.

GREGG R. STODER, PRINCIPAL
Name Title Signature Date 2/7/14

COMcheck Software Version 3.9.2
Inspection Checklist

Requirements: 100.0% were addressed directly in the COMcheck software

Text in the "Comments/Assumptions" column is provided by the user in the COMcheck Requirements screen. For each requirement, the user certifies that a code requirement will be met and how that is documented, or that an exception is being claimed. Where compliance is itemized in a separate table, a reference to that table is provided.

Table with 3 columns: Standard, Plan Review, Comments/Assumptions. Lists requirements 90.1 (2007) Standard, 5.4.2.2, and 5.4.2.3 with their compliance status.

Additional Comments/Assumptions:

Table with 4 columns: Standard, Framing / Rough-In Inspection, Plans Verified, Field Verified. Lists requirements 90.1 (2007) Standard, 5.4.2.3, 5.4.3.1, 5.4.3.2, 5.4.3.3, 5.4.3.4, 5.4.3.5, 5.4.3.6, 5.4.3.7, 5.4.3.8 with their compliance status.

Additional Comments/Assumptions:

Table with 4 columns: Standard, Framing / Rough-In Inspection, Plans Verified, Field Verified. Lists requirements 90.1 (2007) Standard, 5.4.2.3, 5.4.3.1, 5.4.3.2, 5.4.3.3, 5.4.3.4, 5.4.3.5, 5.4.3.6, 5.4.3.7, 5.4.3.8 with their compliance status.

Additional Comments/Assumptions:

Table with 4 columns: Standard, Insulation Inspection, Plans Verified, Field Verified. Lists requirements 90.1 (2007) Standard, 5.4.3.1, 5.4.3.2, 5.4.3.3, 5.4.3.4, 5.4.3.5, 5.4.3.6, 5.4.3.7, 5.4.3.8 with their compliance status.

Additional Comments/Assumptions:


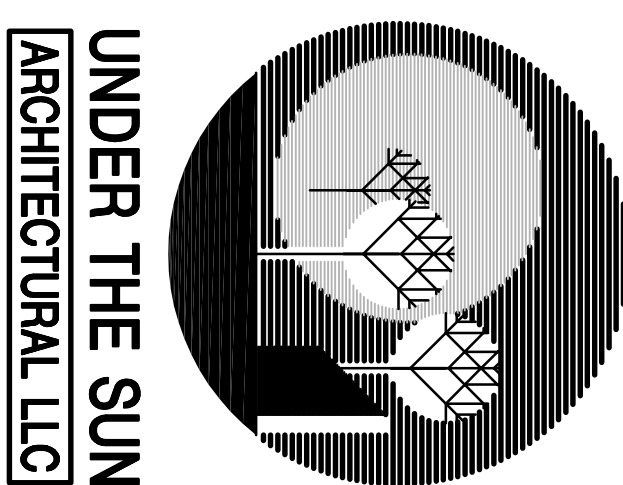
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Additional Comments/Assumptions:

Table with 4 columns: Standard, Insulation Inspection, Plans Verified, Field Verified. Lists requirements 90.1 (2007) Standard, 5.4.3.1, 5.4.3.2, 5.4.3.3, 5.4.3.4, 5.4.3.5, 5.4.3.6, 5.4.3.7, 5.4.3.8 with their compliance status.

Additional Comments/Assumptions:

1 High Impact (Tier 1) 2 Medium Impact (Tier 2) 3 Low Impact (Tier 3)

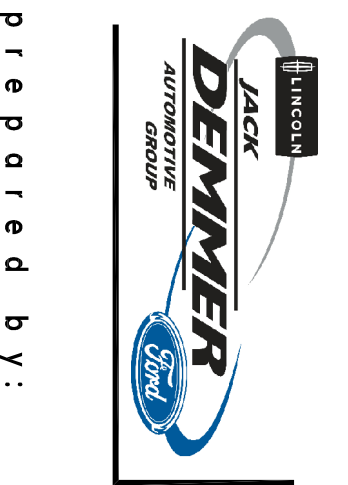

11022 Mountain Dove Lane
South Lyon, MI 48178

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CORPORATE: 5848 209

PROJECT TITLE

DENMIER
QUICKLANE


3740
MICHIGAN AVE
WAYNE, MI

SHEET TITLE

ENERGY CODE
ENVELOPE DATA

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PROJECT NUMBER


13002

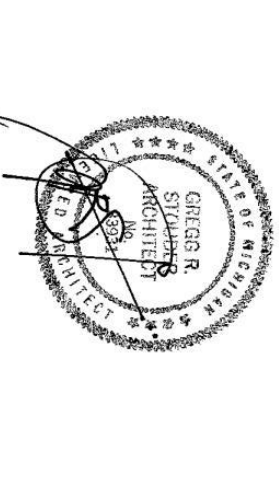drawn USA

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issued date

BIDS AND PERMITS 02-07-2014

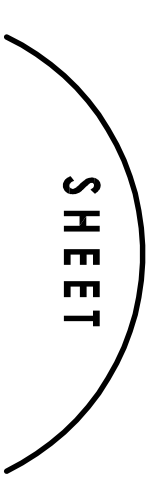

T-002

ROOM FINISH SCHEDULE

ROOM NO.	ROOM NAME	FLOOR	BASE	NORTH	EAST	SOUTH	WEST	MATL	FINISH	HEIGHT	REMARKS
01	CLOSET/WALKING	CT-1	CT-3	PT-1	PT-1	PT-1	PT-2	ACT-1	WHITE	8'-0"	
02	ALCOVE	CT-1	CT-3	PT-1	PT-1	PT-1	PT-1	ACT-1	WHITE	8'-0"	
03	HALL	CT-1	CT-3	PT-1	PT-1	PT-1	PT-1	ACT-1	WHITE	8'-0"	
04	MEN	CT-2	CT-2	PT-1	PT-1	PT-1	PT-1	GTP BD	PT-1	8'-0"	* REN-2
05	WOMEN	CT-2	CT-2	PT-1	PT-1	PT-1	PT-1	GTP BD	PT-1	8'-0"	* REN-2
06	RESTROOM	CT-2	CT-2	PT-1	PT-1	PT-1	PT-1	GTP BD	PT-1	8'-0"	* REN-2
07	LOCKERS	CT-2	CT-3	PT-1	PT-1	PT-1	PT-1	GTP BD	PT-1	8'-0"	* REN-2
08	HALL	CT-2	CT-3	PT-1	PT-1	PT-1	PT-1	ACT-2	WHITE	8'-0"	
09	BREAK ROOM	CT-2	CT-3	PT-1	PT-1	PT-1	PT-1	ACT-2	WHITE	8'-0"	
10	MACHINE ROOM	CT-2	CT-3	PT-1	PT-1	PT-1	PT-1	ACT-2	WHITE	8'-0"	
11	SERVERS	CT-2	CT-3	PT-1	PT-1	PT-1	PT-1	ACT-2	WHITE	8'-0"	* REN-1
12	SERVICE MANAGER	CT-2	CT-3	PT-1	PT-1	PT-1	PT-1	ACT-2	WHITE	8'-0"	
13	SECURITY	CT-2	CT-3	PT-1	PT-1	PT-1	PT-1	ACT-2	WHITE	8'-0"	
14	SECURITY	CT-2	CT-3	PT-1	PT-1	PT-1	PT-1	ACT-2	WHITE	8'-0"	* REN-1
15	SECURITY	CT-2	CT-3	PT-1	PT-1	PT-1	PT-1	ACT-2	WHITE	8'-0"	* REN-1
16	SECURITY	CT-2	CT-3	PT-1	PT-1	PT-1	PT-1	ACT-2	WHITE	8'-0"	* REN-1
17	MEZZANINE	CT-2	CT-3	PT-1	PT-1	PT-1	PT-1	ACT-2	WHITE	8'-0"	

ROOM FINISH SCHEDULE REVISIONS:
 REN-1 PT-3 FROM PT-1 TO 1/4" AFF TO TOP OF WALL.
 REN-2 CEILING TILE TO 1" HIGH EXCEPT WHERE ELEVATIONS ON A-100 SHOW WALL TILE.


DOOR SCHEDULE

DOOR NO.	DOOR SIZE	DOOR	ELEV.	FINISH	FRAME	ELEV.	FINISH	HEAD	JAMB	SET	REMARKS
01A	3'-0" x 1'-0"	B	ST ALUM	ANOD	1/4"Ø	ST ALUM	ANOD	-	-	1	STOREFRONT ALUMINUM DOOR FRAME
01B	3'-0" x 1'-0"	B	NT ALUM	ANOD	6/4"Ø	NT ALUM	ANOD	-	-	2	INTERIOR ALUMINUM DOOR FRAME
02A	3'-0" x 1'-0"	A	WOOD	FACTORY	1	NT ALUM	ANOD	3	4	3	INTERIOR ALUMINUM REVE
02B	3'-0" x 1'-0"	A	NT ALUM	ANOD	1	NT ALUM	ANOD	3	5	6	INTERIOR ALUMINUM REVE
02C	3'-0" x 1'-0"	A	NT ALUM	ANOD	1	NT ALUM	ANOD	3	5	6	INTERIOR ALUMINUM REVE
02D	3'-0" x 1'-0"	A	NT ALUM	ANOD	1	NT ALUM	ANOD	3	5	6	INTERIOR ALUMINUM REVE
02E	3'-0" x 1'-0"	A	NT ALUM	ANOD	1	NT ALUM	ANOD	3	5	6	INTERIOR ALUMINUM REVE
02F	3'-0" x 1'-0"	A	NT ALUM	ANOD	1	NT ALUM	ANOD	3	5	6	INTERIOR ALUMINUM REVE
02G	3'-0" x 1'-0"	A	NT ALUM	ANOD	1	NT ALUM	ANOD	3	5	6	INTERIOR ALUMINUM REVE
02H	3'-0" x 1'-0"	A	NT ALUM	ANOD	1	NT ALUM	ANOD	3	5	6	INTERIOR ALUMINUM REVE
02I	3'-0" x 1'-0"	A	NT ALUM	ANOD	1	NT ALUM	ANOD	3	5	6	INTERIOR ALUMINUM REVE
02J	3'-0" x 1'-0"	A	NT ALUM	ANOD	1	NT ALUM	ANOD	3	5	6	INTERIOR ALUMINUM REVE
02K	3'-0" x 1'-0"	A	NT ALUM	ANOD	1	NT ALUM	ANOD	3	5	6	INTERIOR ALUMINUM REVE
02L	3'-0" x 1'-0"	A	NT ALUM	ANOD	1	NT ALUM	ANOD	3	5	6	INTERIOR ALUMINUM REVE
02M	3'-0" x 1'-0"	A	NT ALUM	ANOD	1	NT ALUM	ANOD	3	5	6	INTERIOR ALUMINUM REVE
02N	3'-0" x 1'-0"	A	NT ALUM	ANOD	1	NT ALUM	ANOD	3	5	6	INTERIOR ALUMINUM REVE
02O	3'-0" x 1'-0"	A	NT ALUM	ANOD	1	NT ALUM	ANOD	3	5	6	INTERIOR ALUMINUM REVE
02P	3'-0" x 1'-0"	A	NT ALUM	ANOD	1	NT ALUM	ANOD	3	5	6	INTERIOR ALUMINUM REVE
02Q	3'-0" x 1'-0"	A	NT ALUM	ANOD	1	NT ALUM	ANOD	3	5	6	INTERIOR ALUMINUM REVE
02R	3'-0" x 1'-0"	A	NT ALUM	ANOD	1	NT ALUM	ANOD	3	5	6	INTERIOR ALUMINUM REVE
02S	3'-0" x 1'-0"	A	NT ALUM	ANOD	1	NT ALUM	ANOD	3	5	6	INTERIOR ALUMINUM REVE
02T	3'-0" x 1'-0"	A	NT ALUM	ANOD	1	NT ALUM	ANOD	3	5	6	INTERIOR ALUMINUM REVE
02U	3'-0" x 1'-0"	A	NT ALUM	ANOD	1	NT ALUM	ANOD	3	5	6	INTERIOR ALUMINUM REVE
02V	3'-0" x 1'-0"	A	NT ALUM	ANOD	1	NT ALUM	ANOD	3	5	6	INTERIOR ALUMINUM REVE
02W	3'-0" x 1'-0"	A	NT ALUM	ANOD	1	NT ALUM	ANOD	3	5	6	INTERIOR ALUMINUM REVE
02X	3'-0" x 1'-0"	A	NT ALUM	ANOD	1	NT ALUM	ANOD	3	5	6	INTERIOR ALUMINUM REVE
02Y	3'-0" x 1'-0"	A	NT ALUM	ANOD	1	NT ALUM	ANOD	3	5	6	INTERIOR ALUMINUM REVE
02Z	3'-0" x 1'-0"	A	NT ALUM	ANOD	1	NT ALUM	ANOD	3	5	6	INTERIOR ALUMINUM REVE


INTERIOR FINISHES

- ACT-1 USG SANDRIT WHITE
2" x 2" x 3/4" WITH FLA EDGE
GRID - USG FINELINE 3 DXF
WHITE
- ACT-2 USG M485 CLIMATEUR WHITE
2" x 2" x 3/4" WITH FLA EDGE
GRID - USG FINELINE 3 DXF
WHITE
- B46 RESIL ENT BASE
ARISTON 4" HIGH WITH COVE
ARISTON 1/2" PARACHENT
- CT-1 CROSSVILLE CERAMIC
EPIRE SERIES UNPOLISHED
V885 GENERAL & GRAY
3" x 14" BULLDOZE BASE
GROUP 18 ON BUILDING PROD.
RADIUM PRO. 1/8" FEELER
- CT-2 SAME AS CT-1 EXCEPT SIZE
14" x 14"
- CT-3 CROSSVILLE CERAMIC
EPIRE SERIES UNPOLISHED
V885 GENERAL & GRAY
3" x 14" BULLDOZE BASE
GROUP 18 ON BUILDING PROD.
RADIUM PRO. 1/8" FEELER
- EPX EPOXY
BY OWENS
- PT-1 PAINT - SHERWIN WILLIAMS
PURE WHITE - SUDOP; EGGSHELL
- PT-2 PAINT - SHERWIN WILLIAMS
TANGO - SUDOP; EGGSHELL
- PT-3 PAINT - SHERWIN WILLIAMS
GAMMLET SEPI - SUDOP
- PT-4 PAINT - SHERWIN WILLIAMS
MINDIL GRAY - SUDOP
SEPI - SUDOP
- SEAR SOLID SURFACE MATERIAL
COLOR: GRAY AS SELECTED BY
OWNER
- VCT ARISTON OVERLAY TEXTURE
STAIN ANTIQUE WHITE


MEZZANINE PLAN

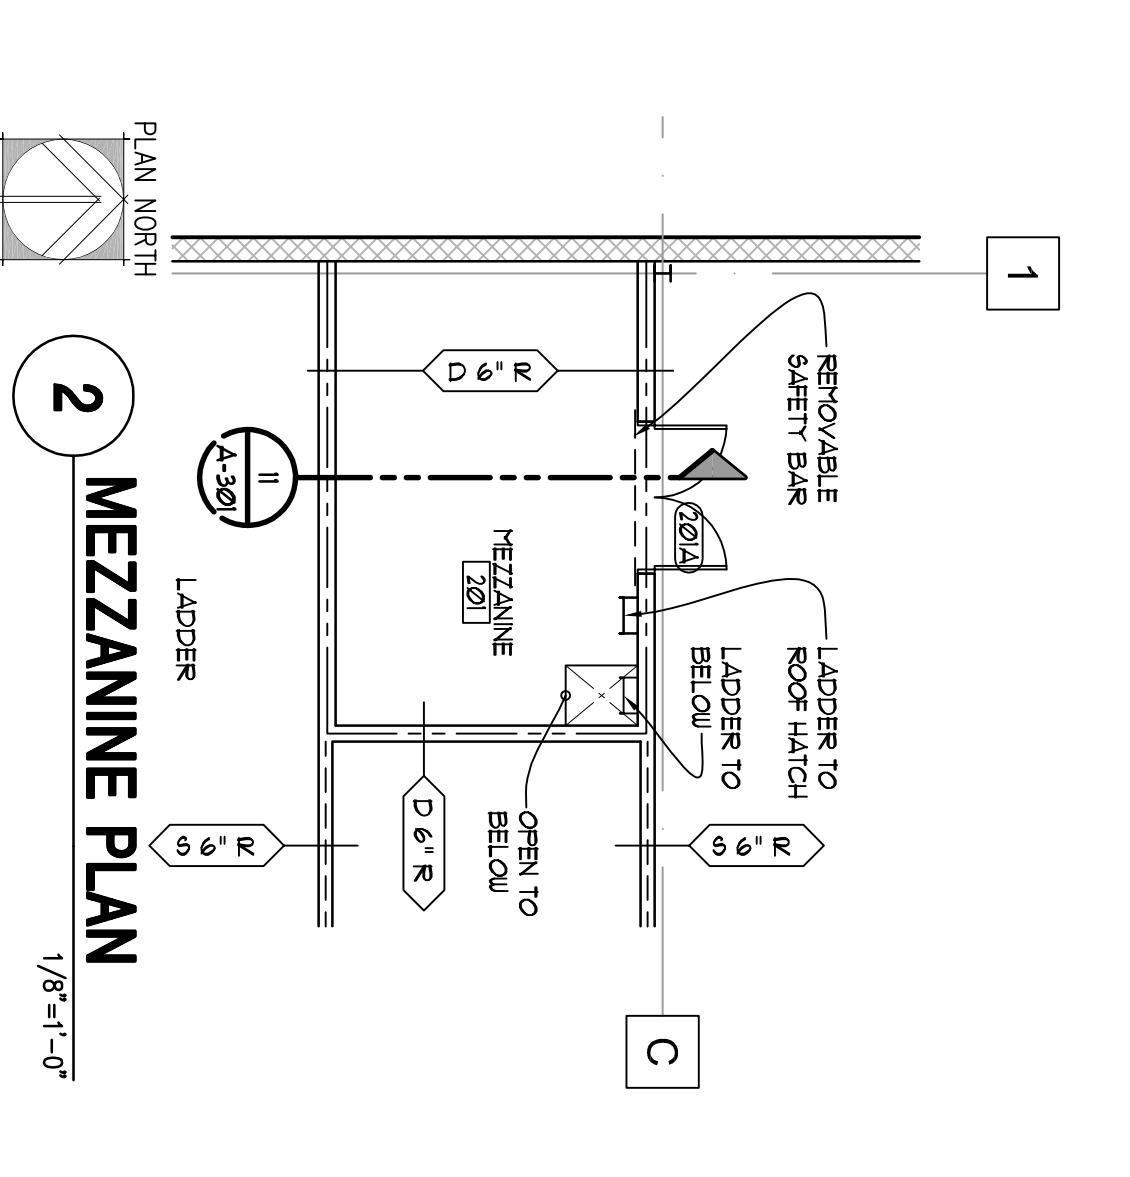


TOP-OF-WALL CONDITIONS

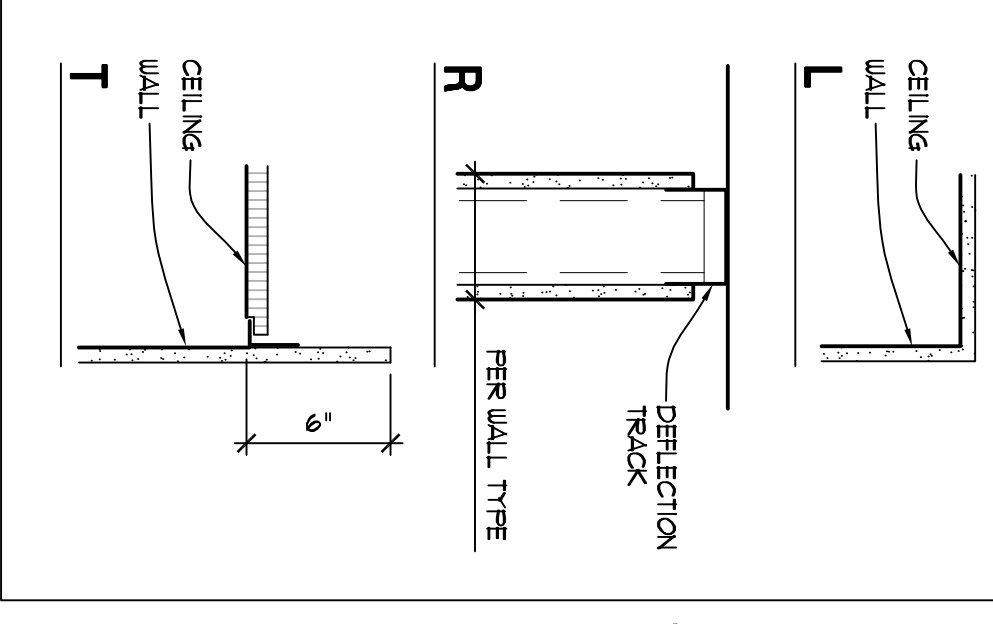


WALL TYPES

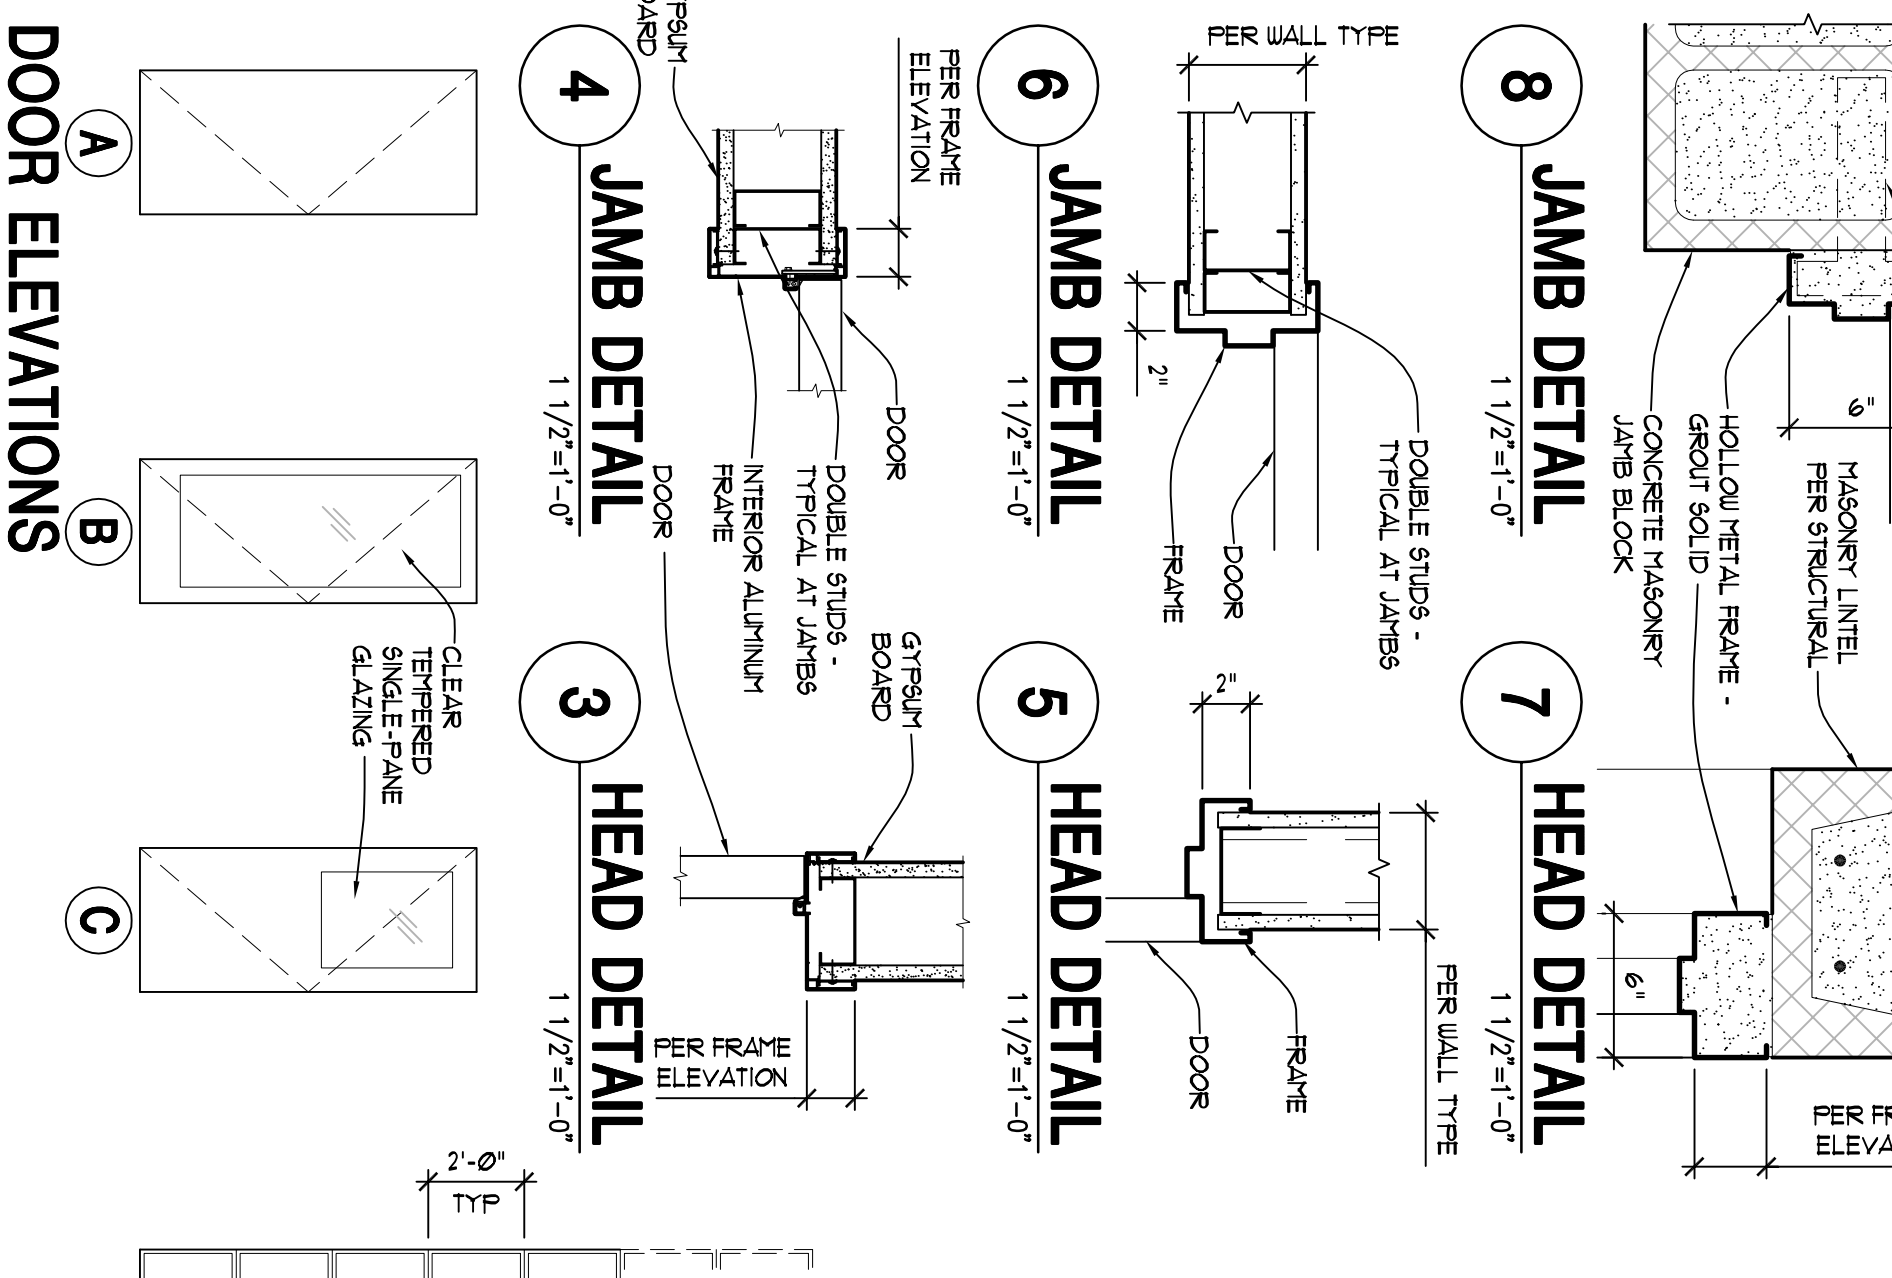

FRAME ELEVATIONS

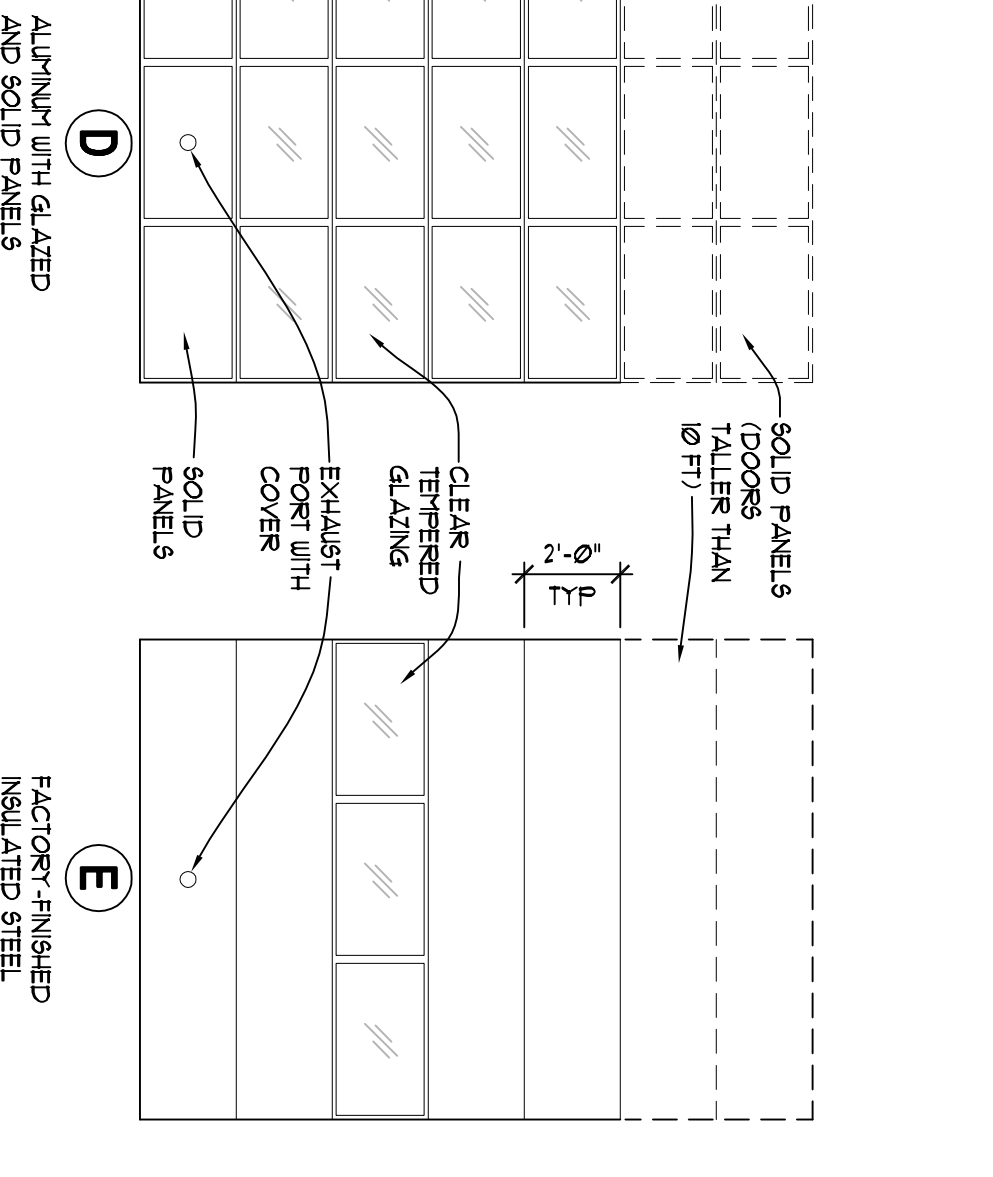

DOOR ELEVATIONS

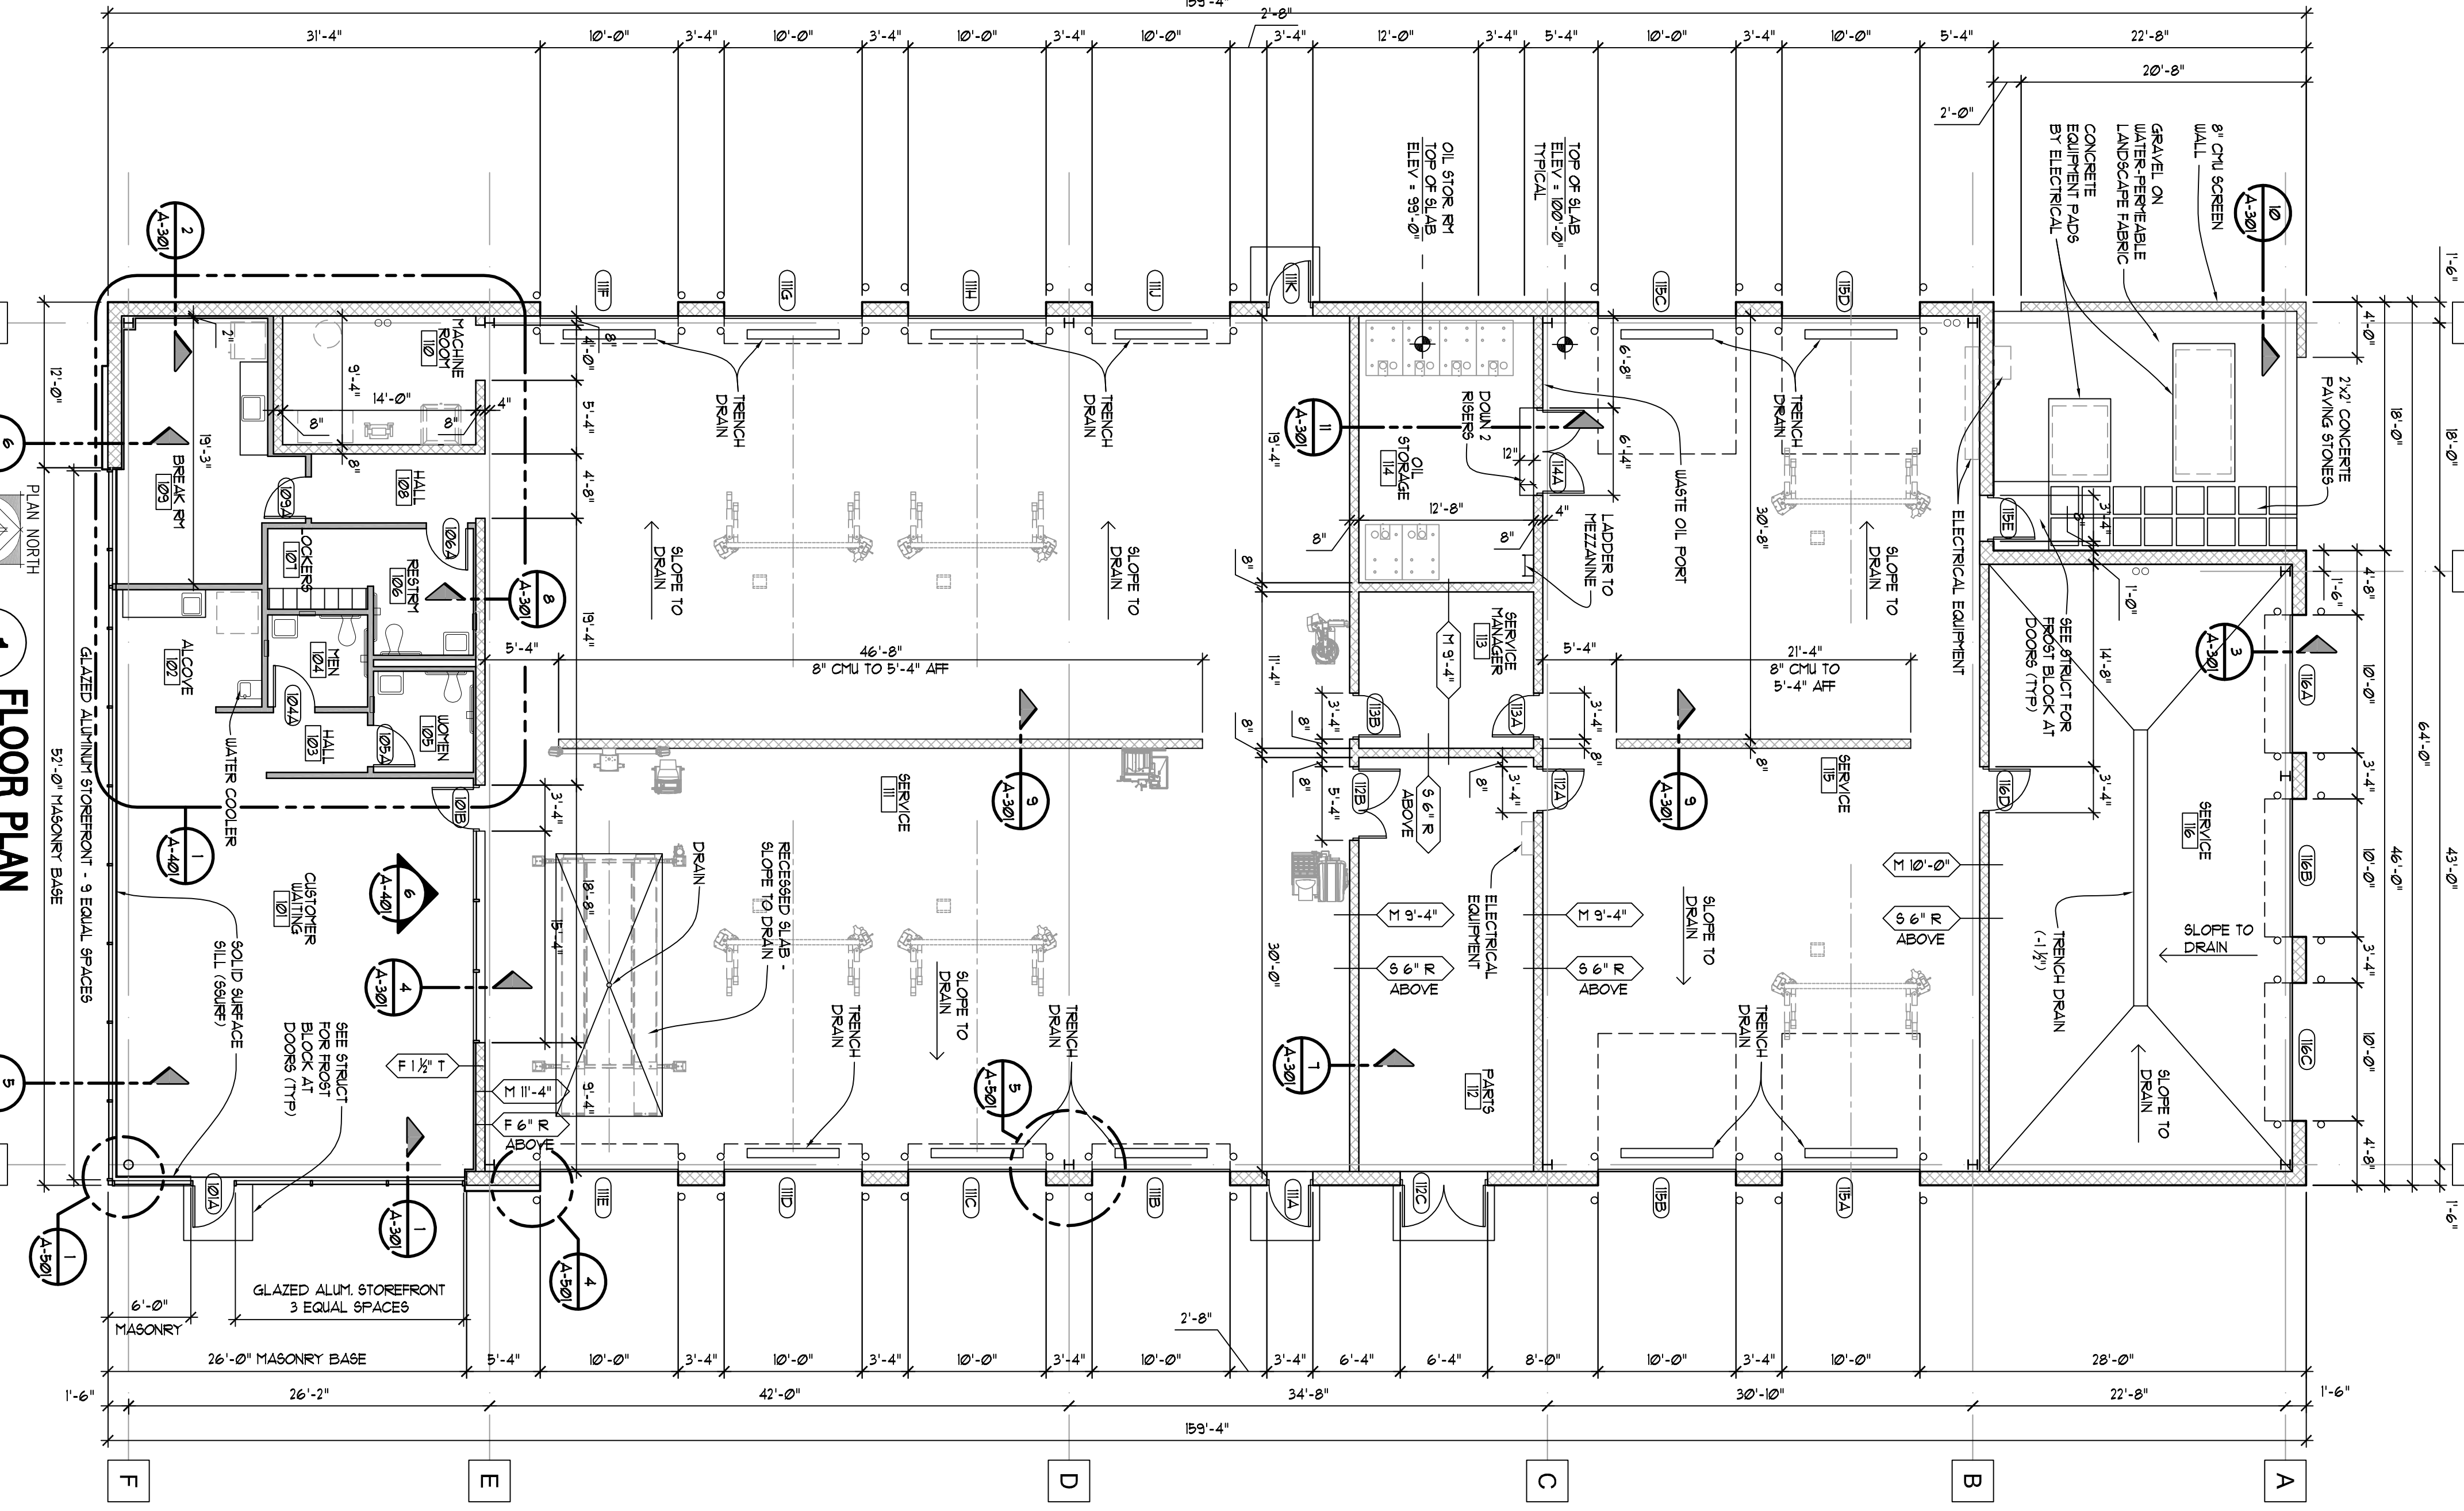

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 COPYRIGHT YEAR 2013

PROJECT TITLE
 DEMMER QUICKLANE
 37410 MICHIGAN AVE
 WAYNE, MI

SHEET TITLE
 FLOOR PLAN AND SCHEDULES

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project number
13002

drawn USA
 approved USA
 issued date 12-20-2013
 BIDS AND PERMITS 02-07-2014





SHEET
A-101

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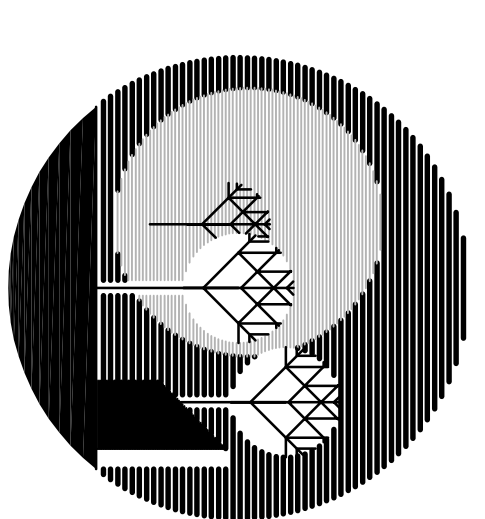
JACK DENEMER ARCHITECTURAL CONSULTANT

EXTERIOR FINISHES

- ACH1 ALUMINUM COMPOSITE METAL PANELS
- ALPOLC HARRINE ALUMINUM 4474412
- BCK1 BRUSH METAL TERN
- CAST STONE COLOR TO MATCH
- SHERWIN WILLIAMS SW6649 TANGO
- CHP CORRUGATED METAL PANEL
- ALCOA 1/8" RIB SIDING
- COLORMELD 3000 SLATE GRAY
- CHU-1 DECORATIVE CONCRETE MASONRY - BOARDMAN FINISHED BY GRAND BLANC CEMENT PRODUCTS
- CHU-2 DECORATIVE CONCRETE MASONRY - UNIFORM FINISHED BY GRAND BLANC CEMENT PRODUCTS
- DLZ 1" LOW E INSULATING GLAZING PROVIDE THERMED GLAZING AS REQUIRED
- SIF STONEFRONT FINISHING

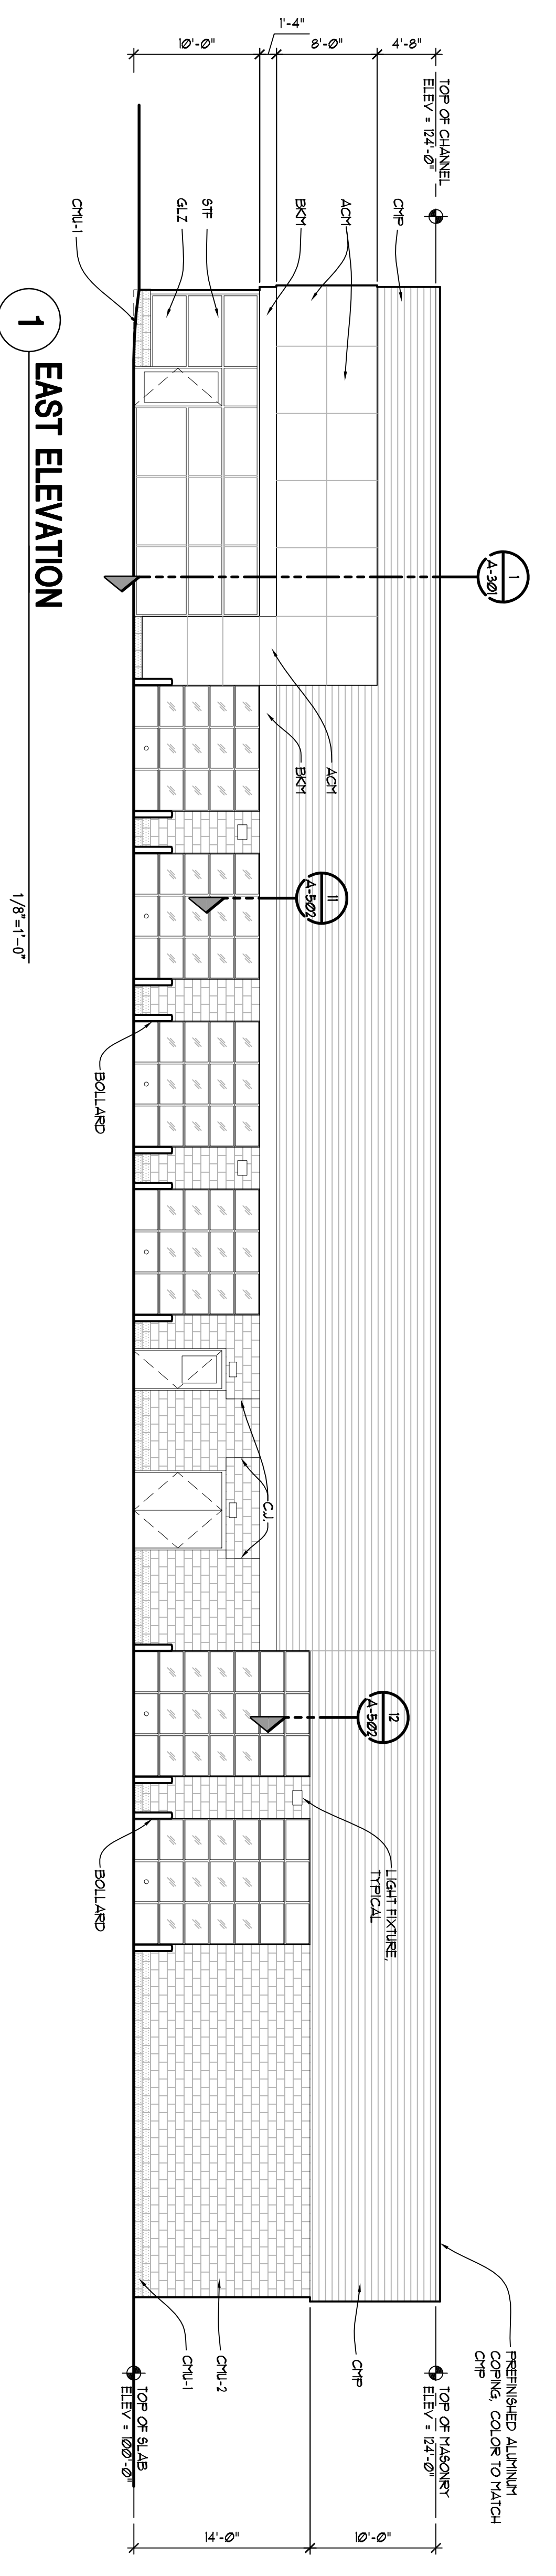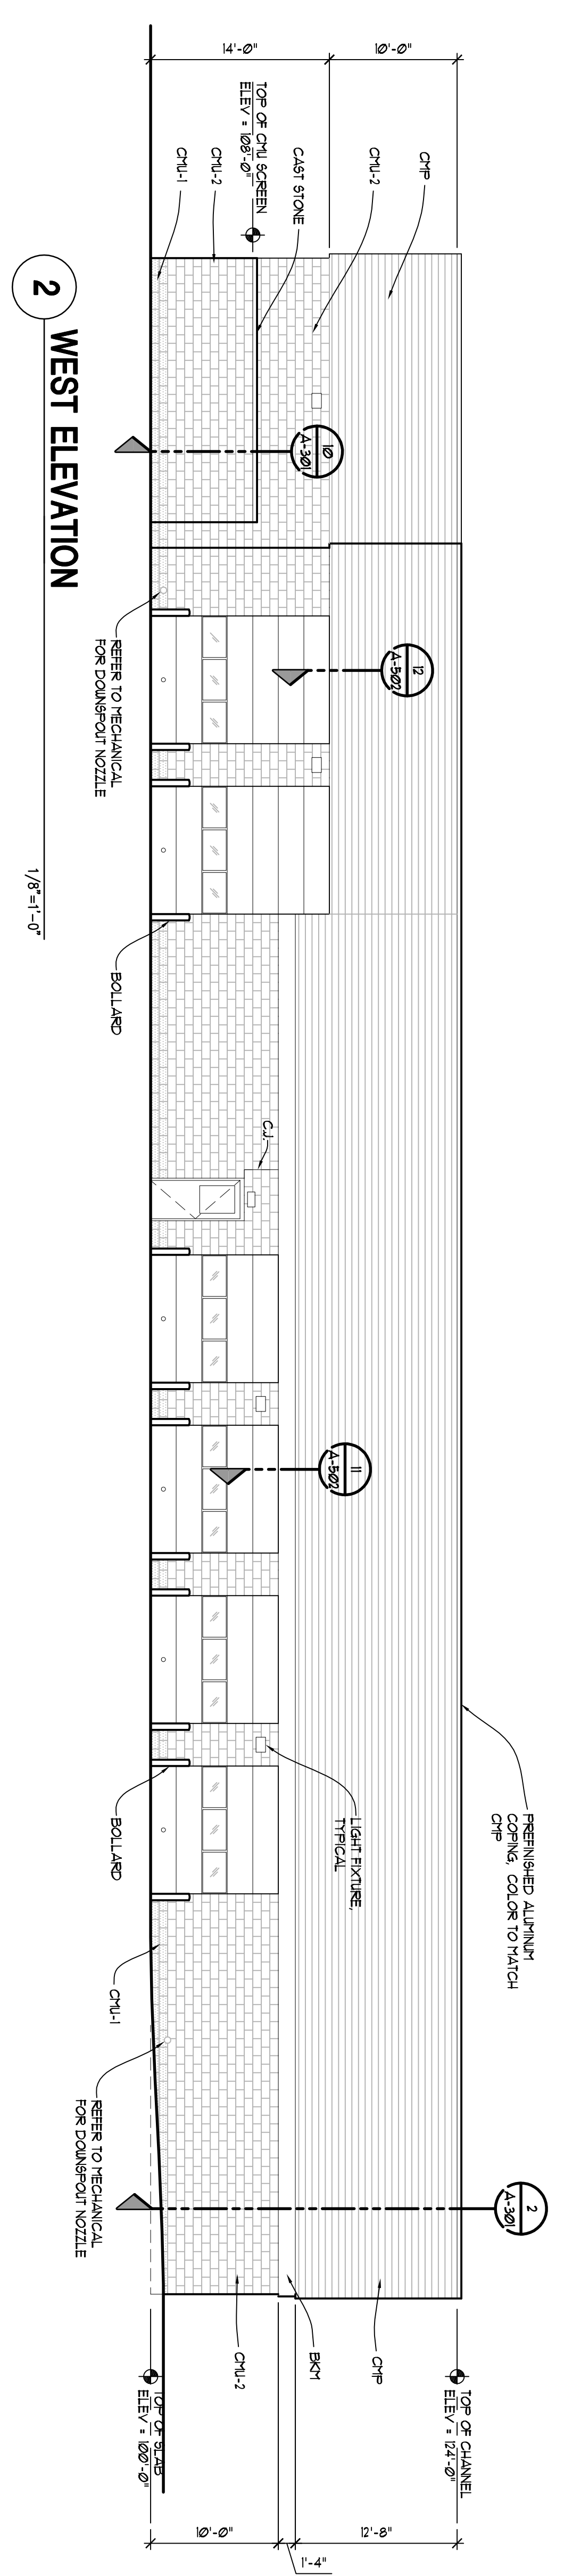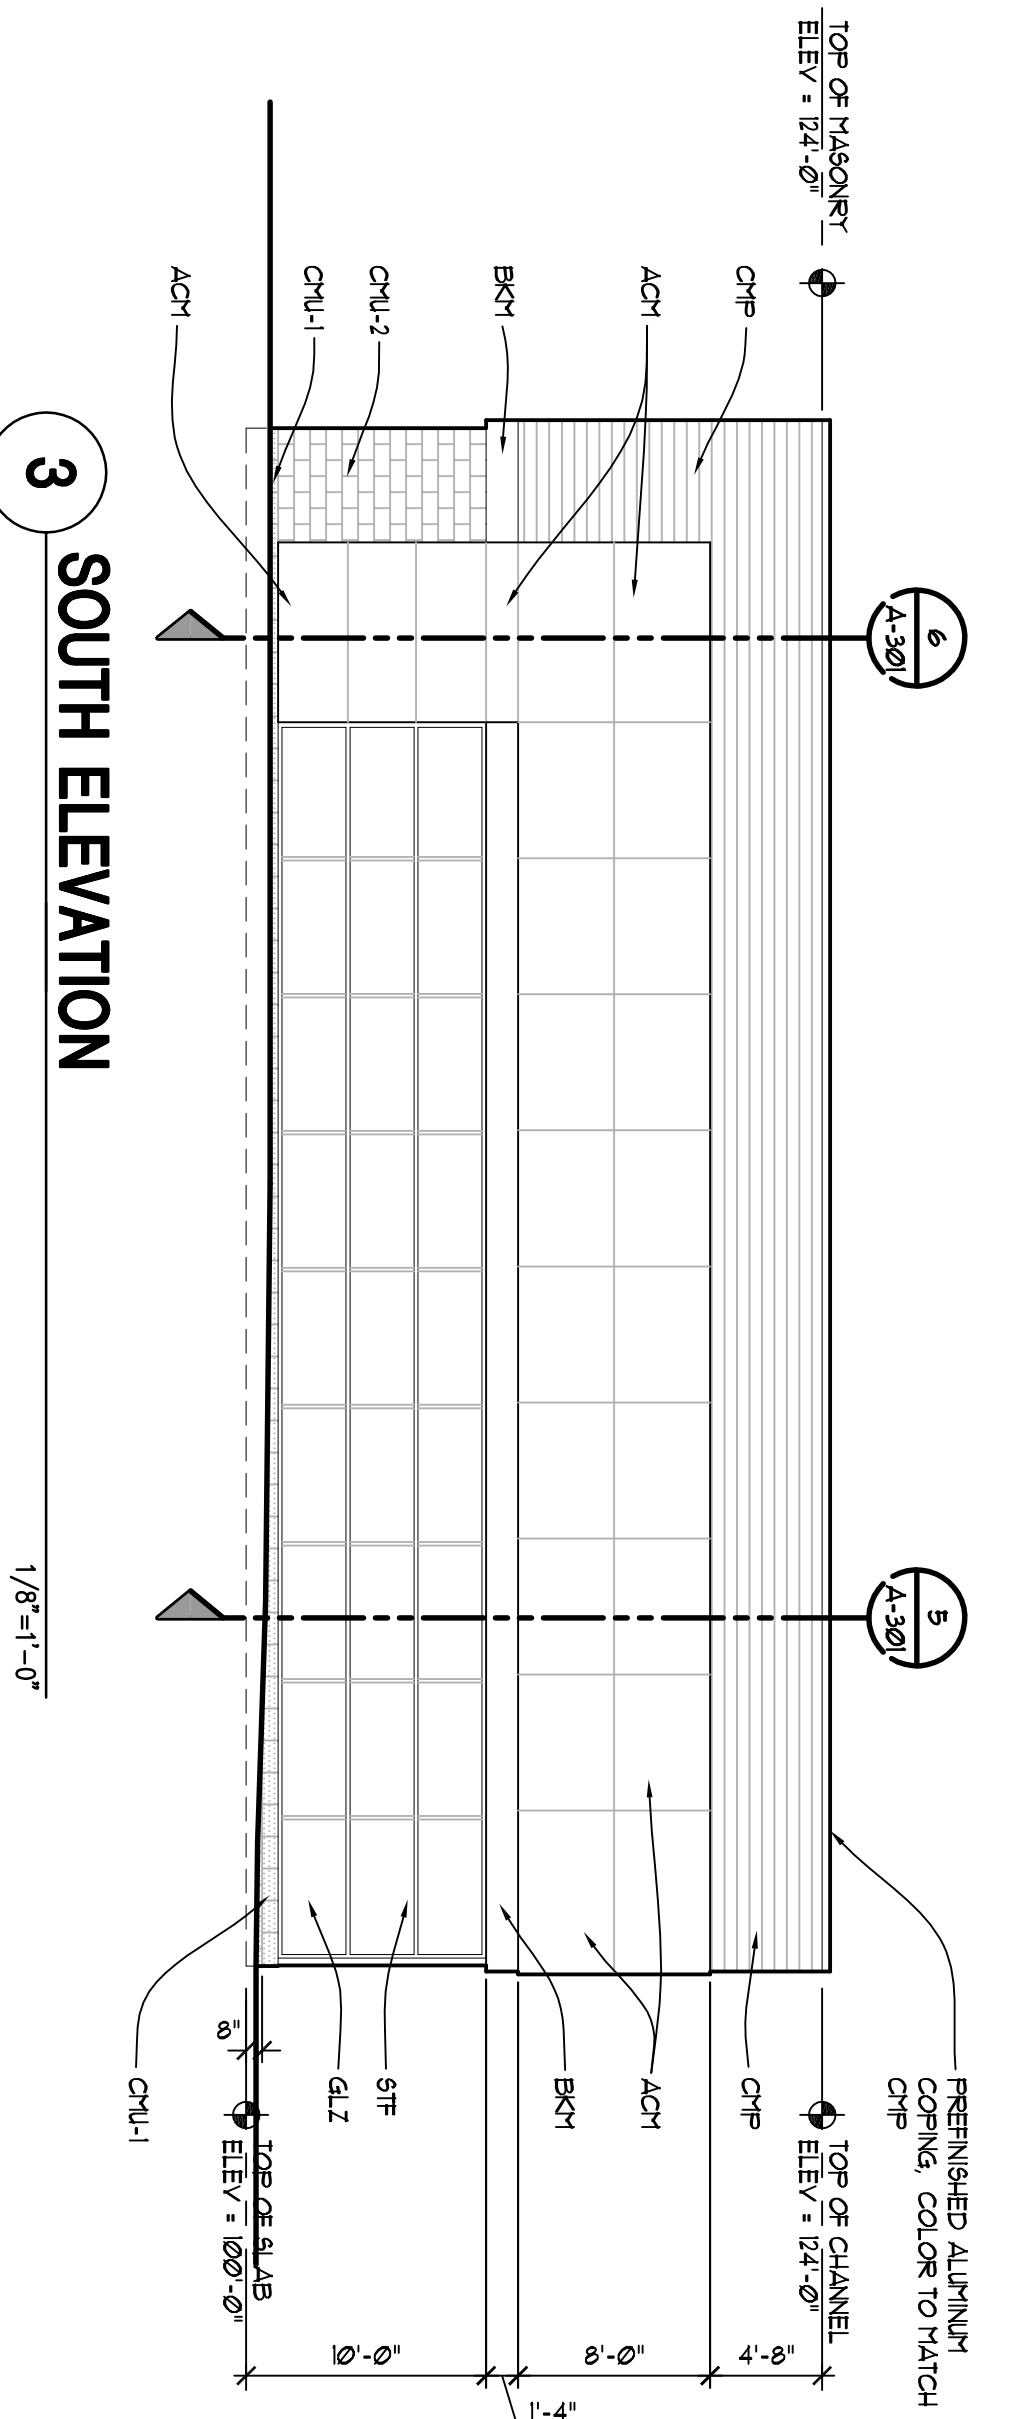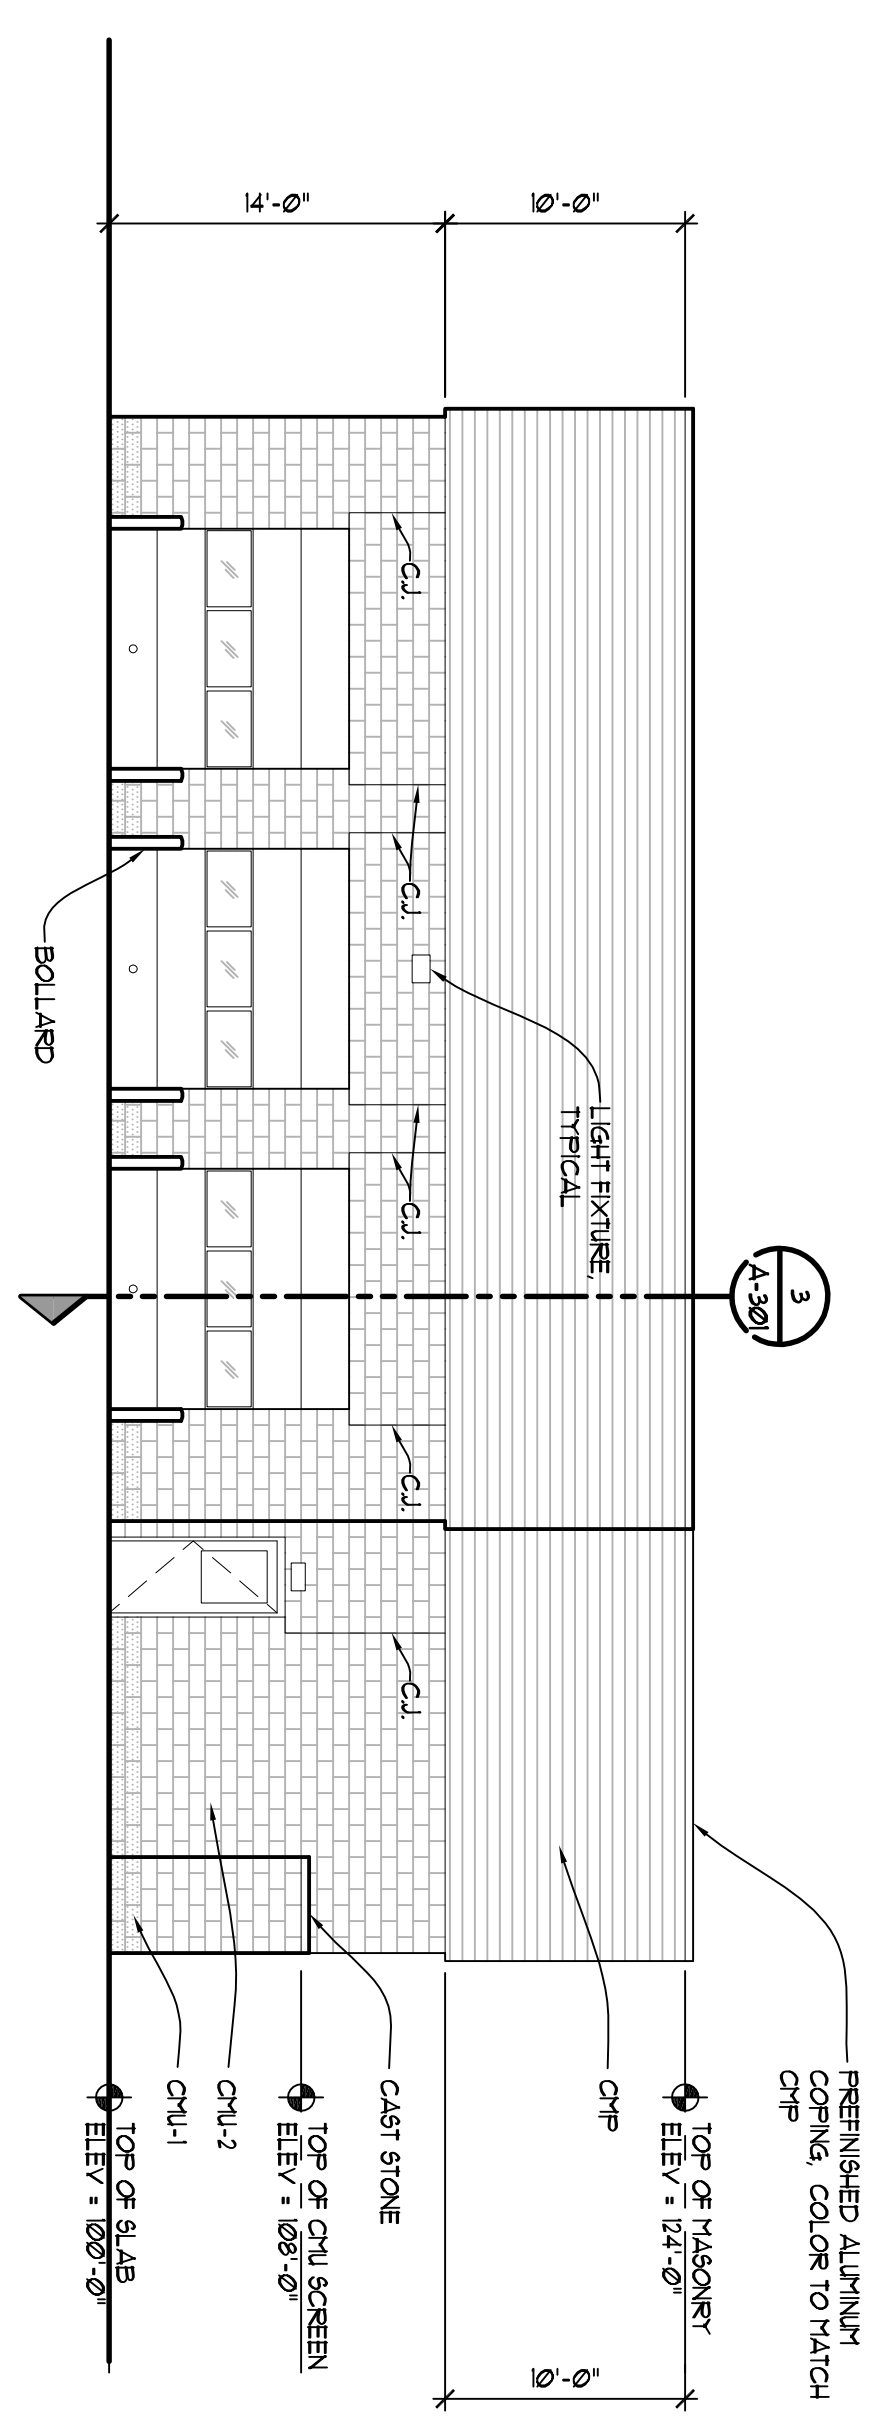

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South Lyon, MI, 48178

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CORPORATE YEAR 2013

project title

DENMIER QUICKLANE


37410 MICHIGAN AVE
WAYNE, MI

sheet title

EXTERIOR ELEVATIONS

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project number

13002

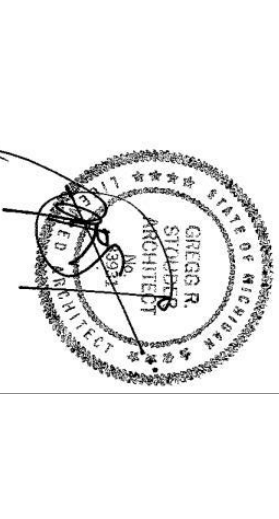drawn USA

approved USA


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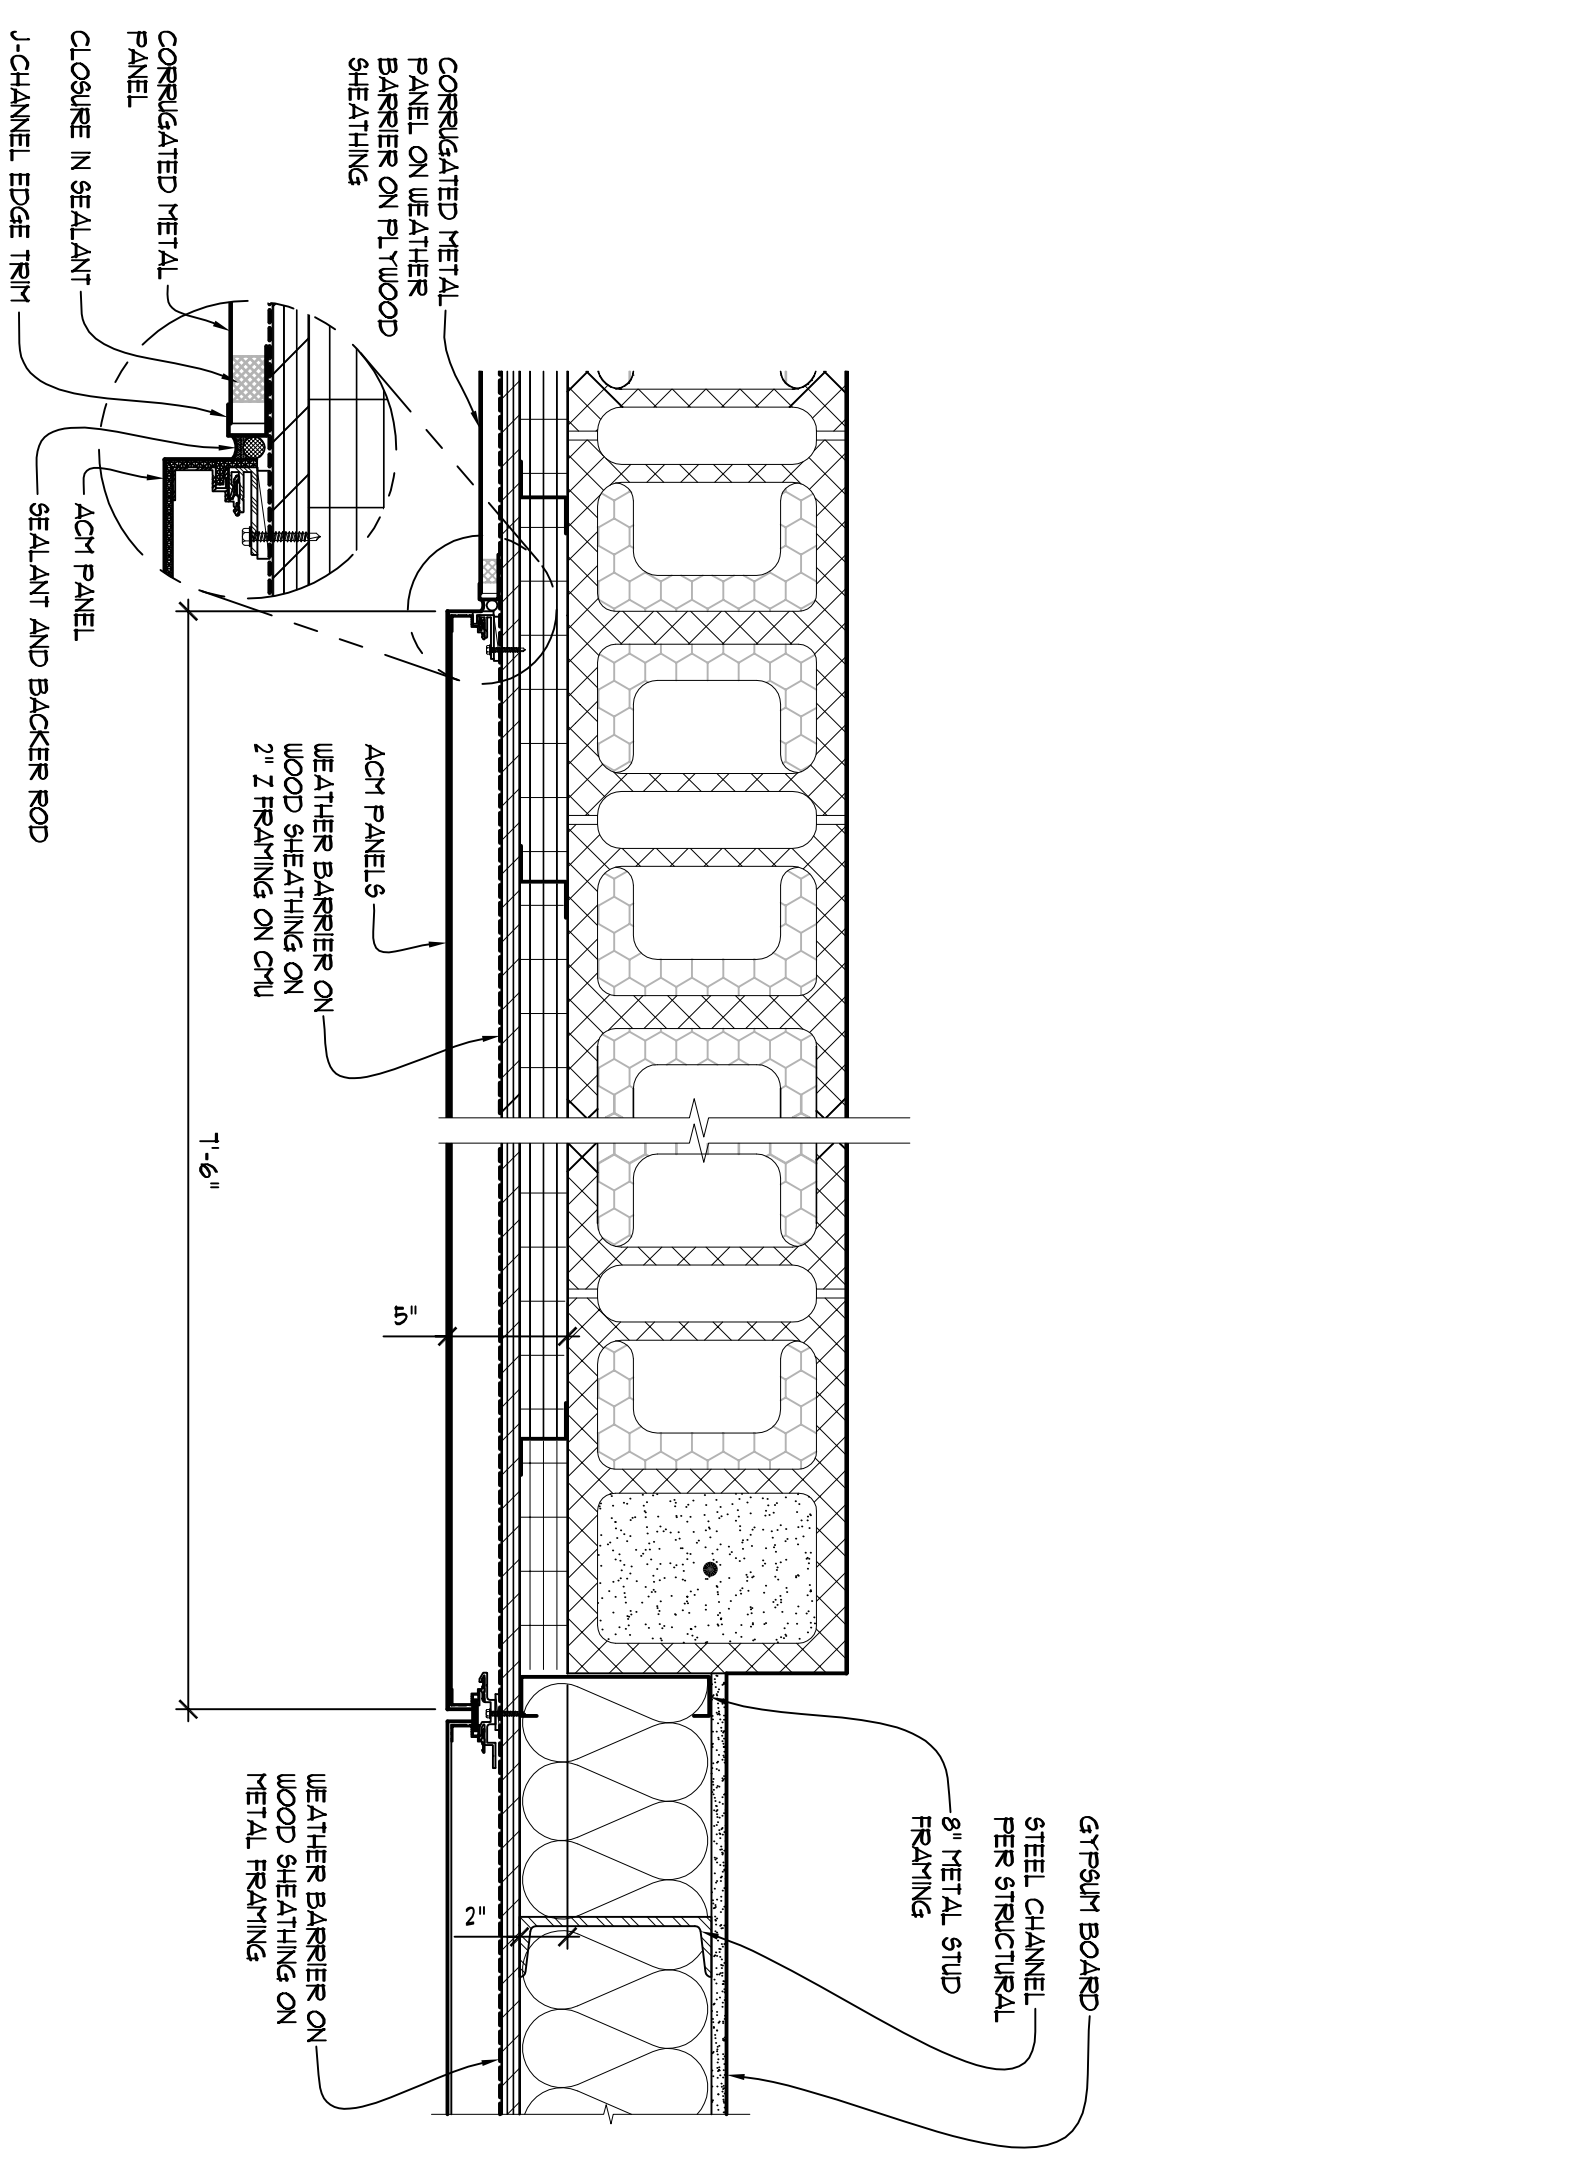
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BIDS AND PERMITS 02-07-2014


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A-201







10 PLAN DETAIL
14'-0" AFF
1 1/2" = 1'-0"

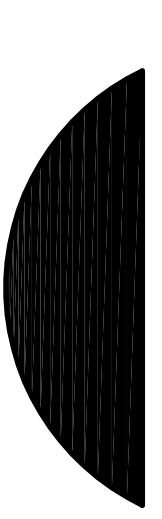

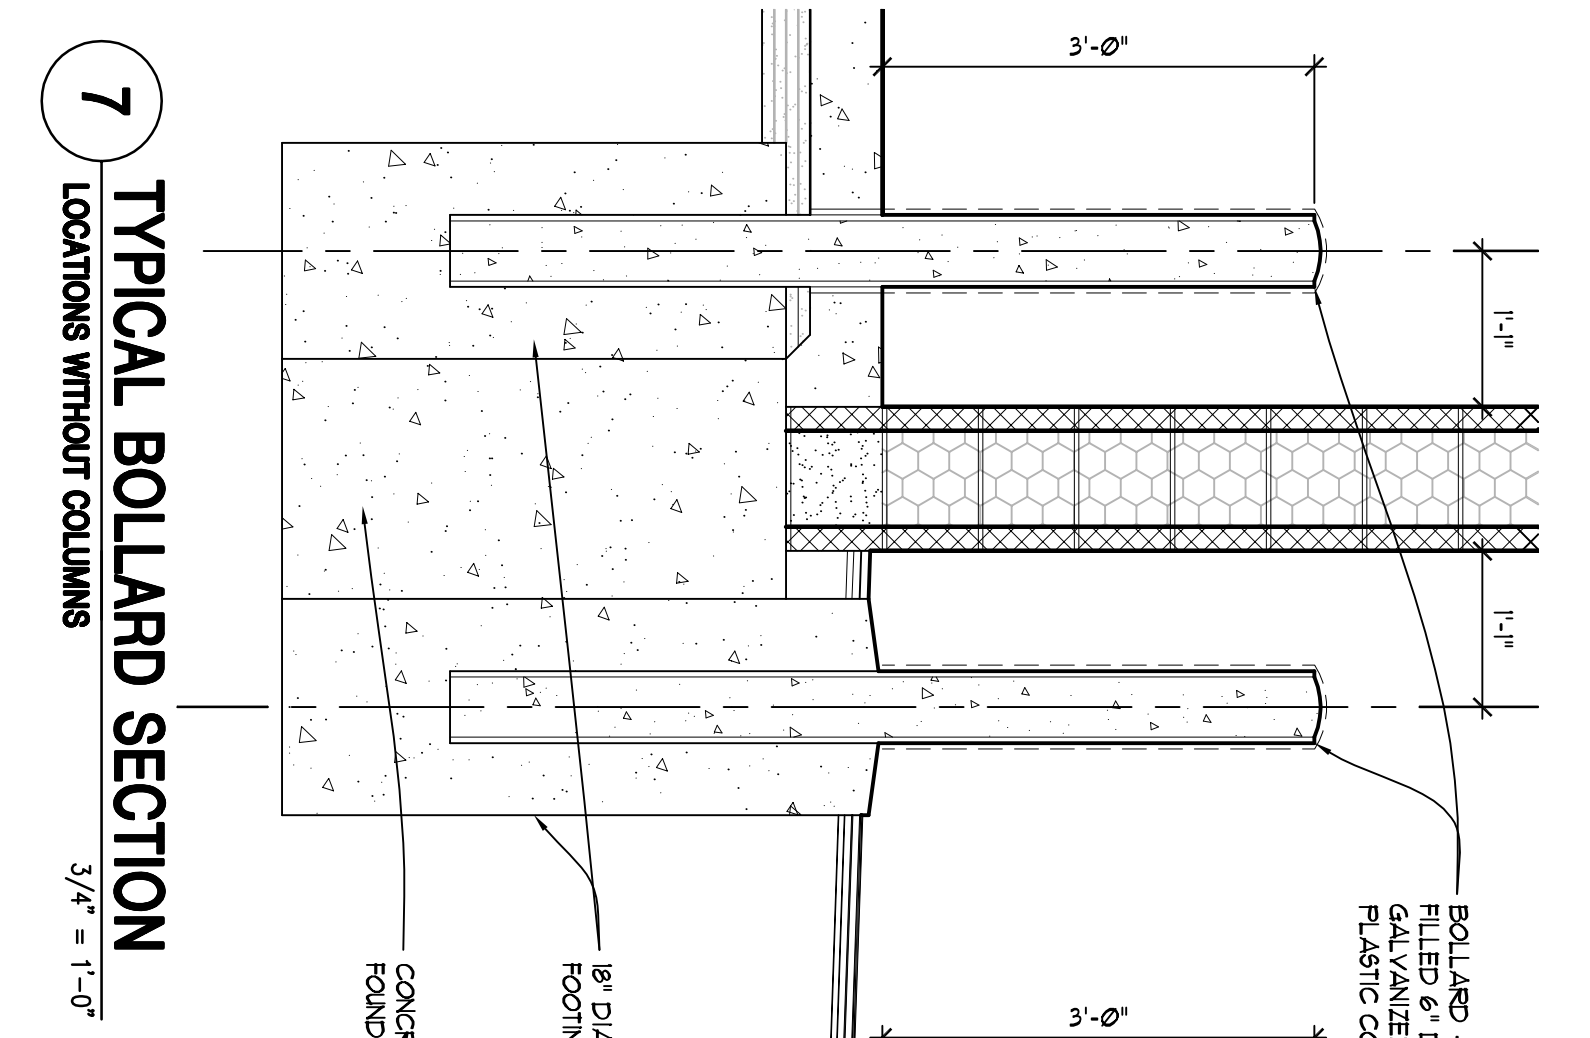
7 TYPICAL BOLLARD SECTION
LOCATIONS WITHOUT COLUMNS
3/4" = 1'-0"

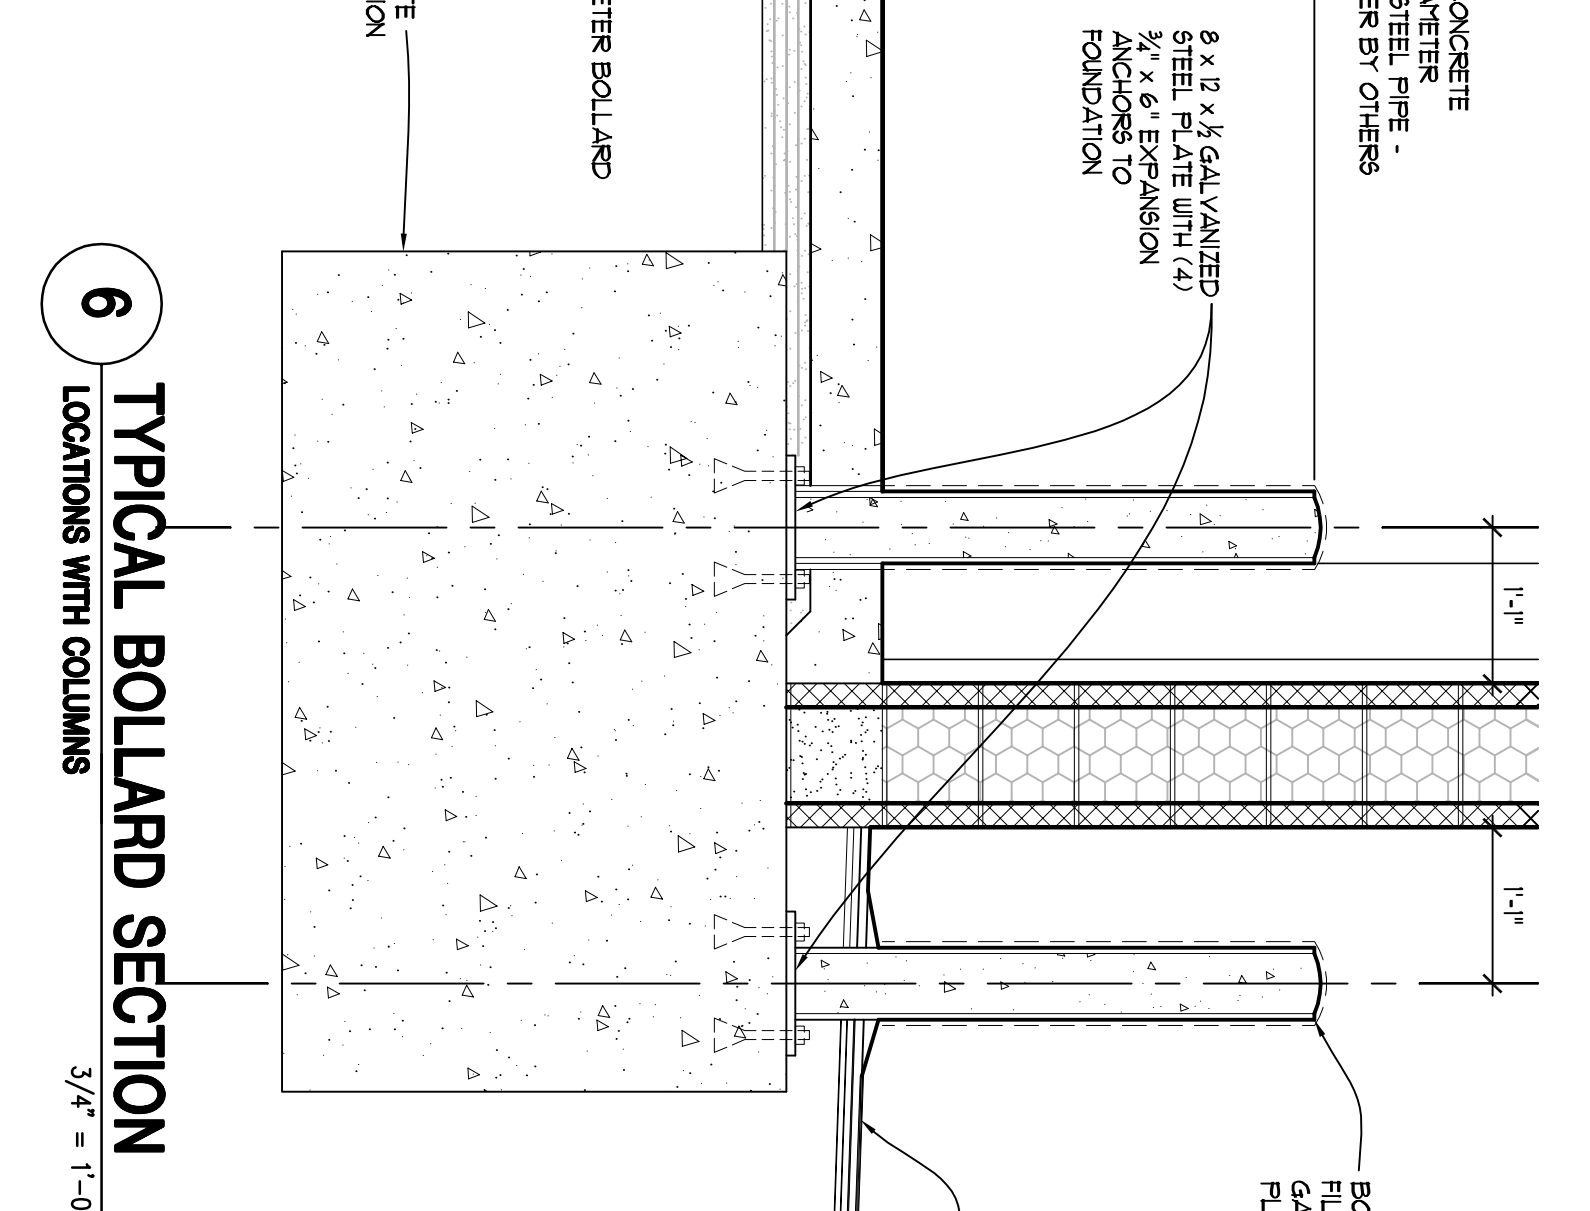


6 TYPICAL BOLLARD SECTION
LOCATIONS WITH COLUMNS
3/4" = 1'-0"

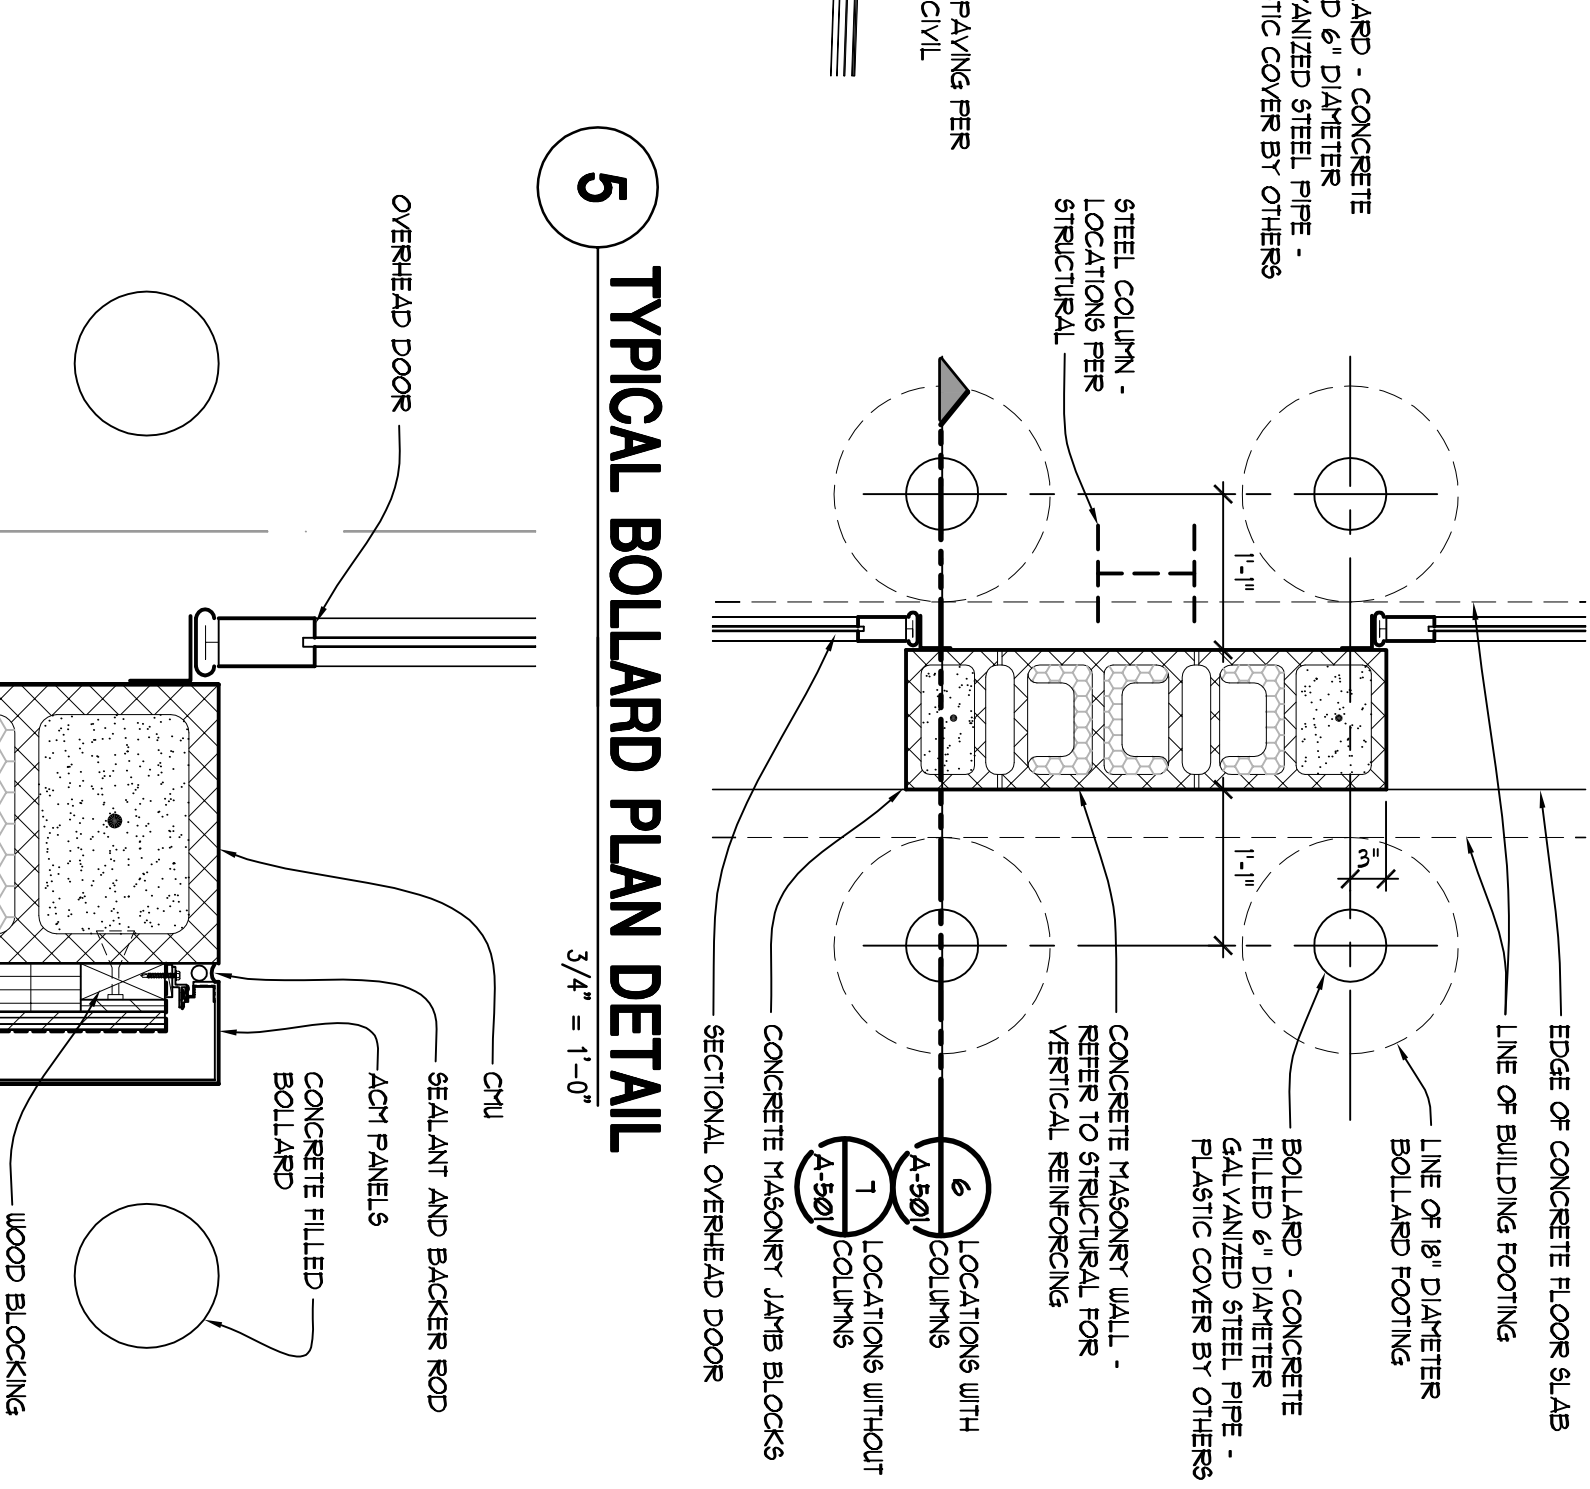


5 TYPICAL BOLLARD PLAN DETAIL
3/4" = 1'-0"

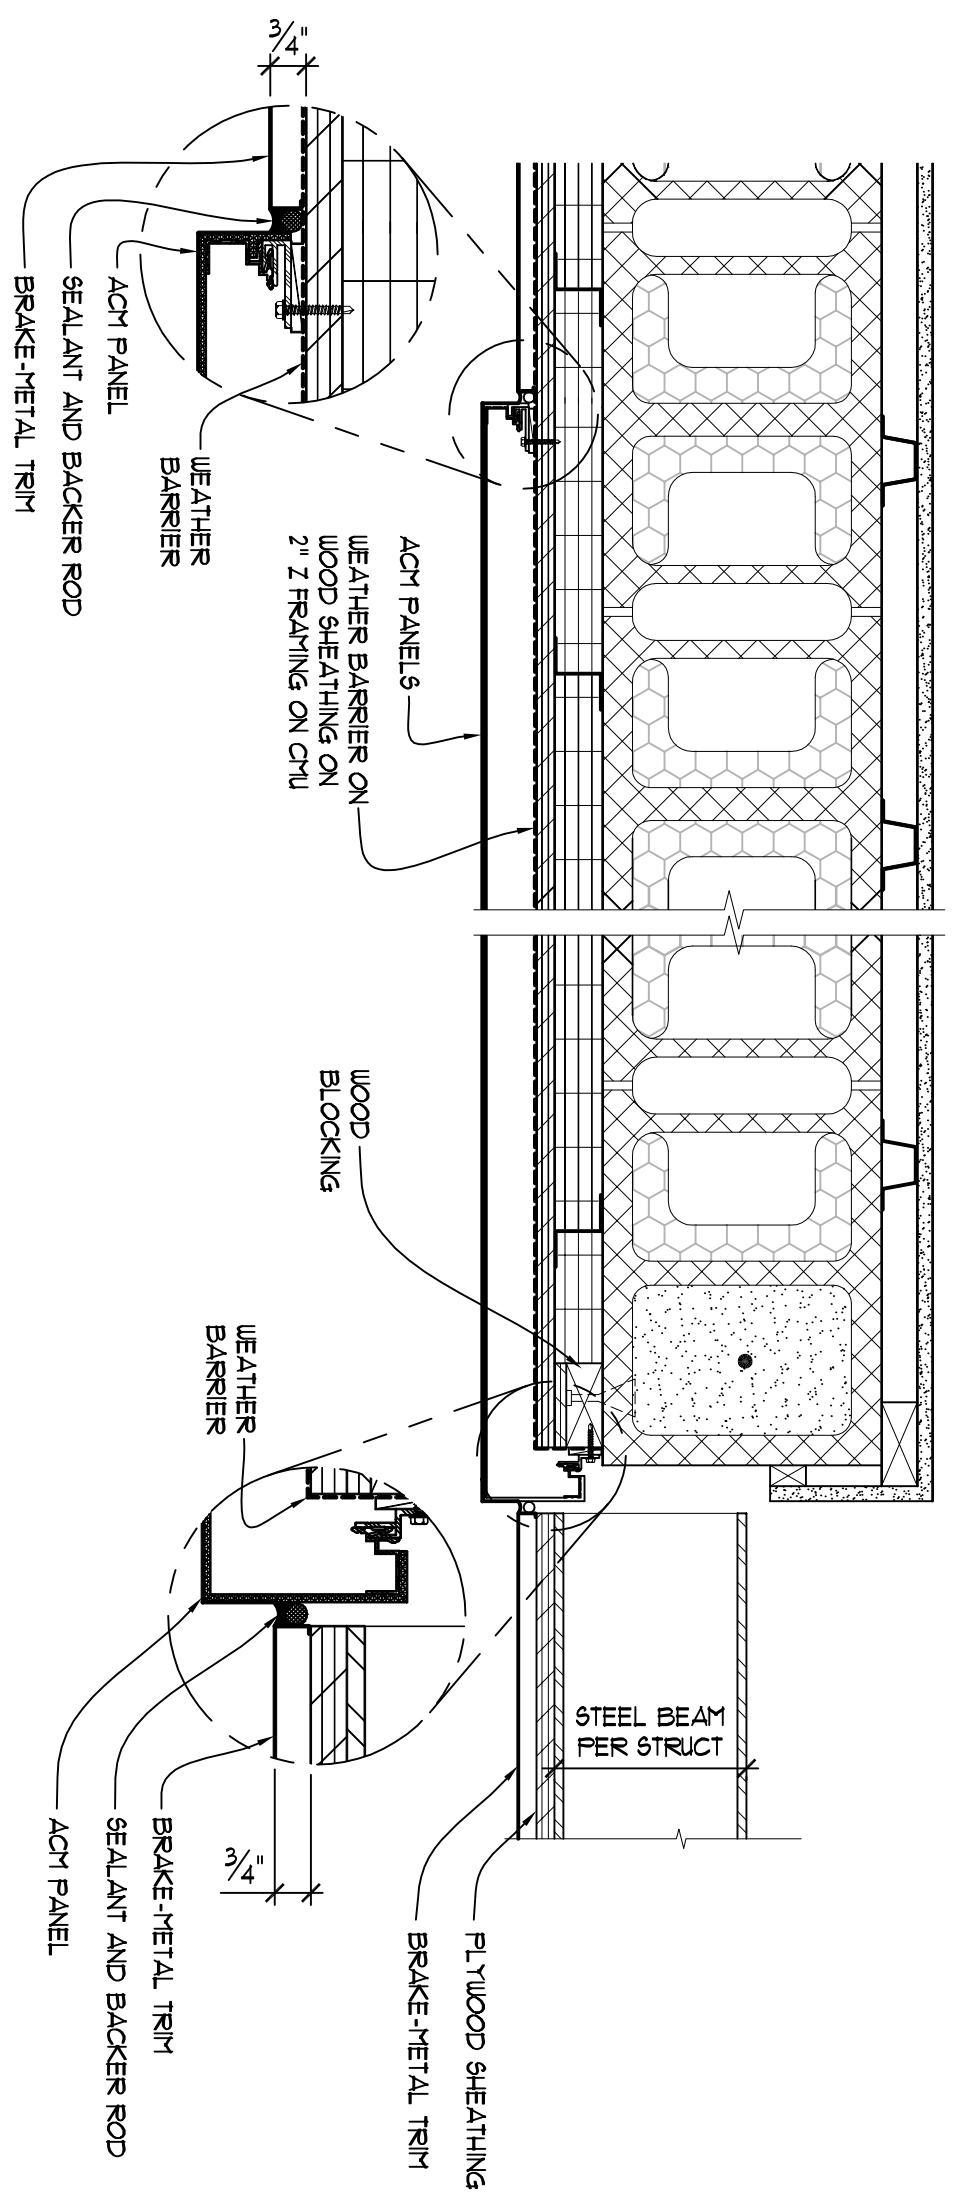


9 PLAN DETAIL
10'-8" AFF
1 1/2" = 1'-0"

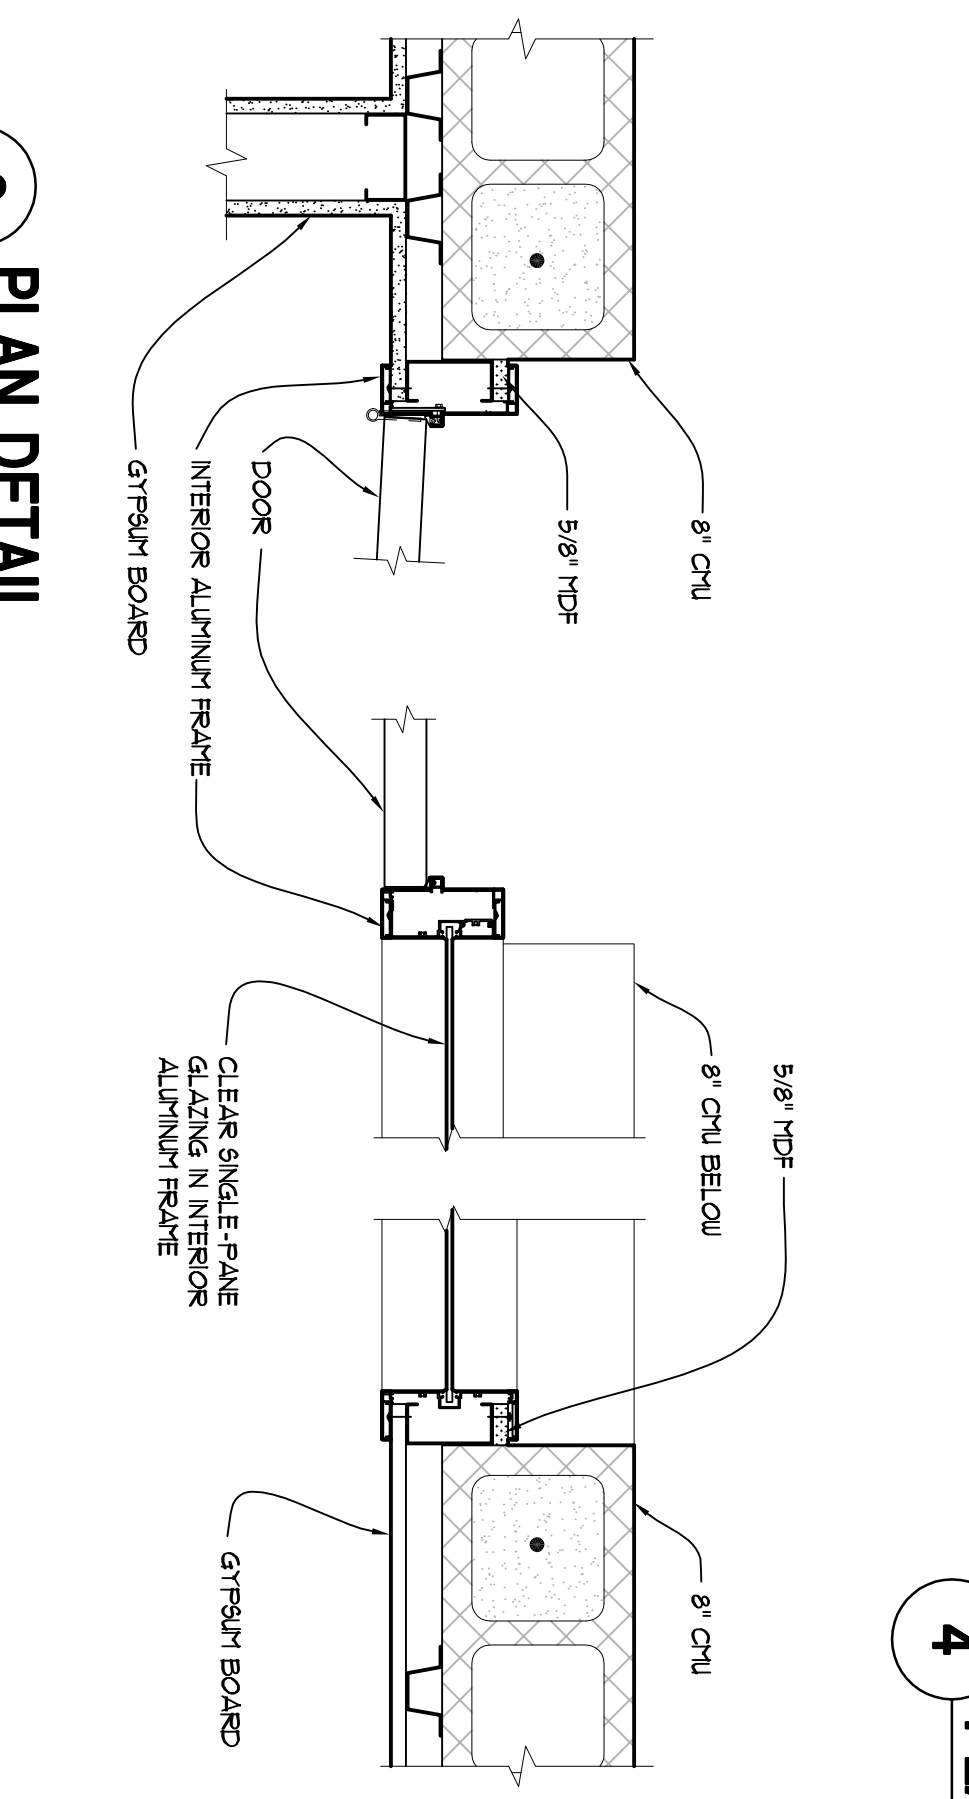


3 PLAN DETAIL
1 1/2" = 1'-0"

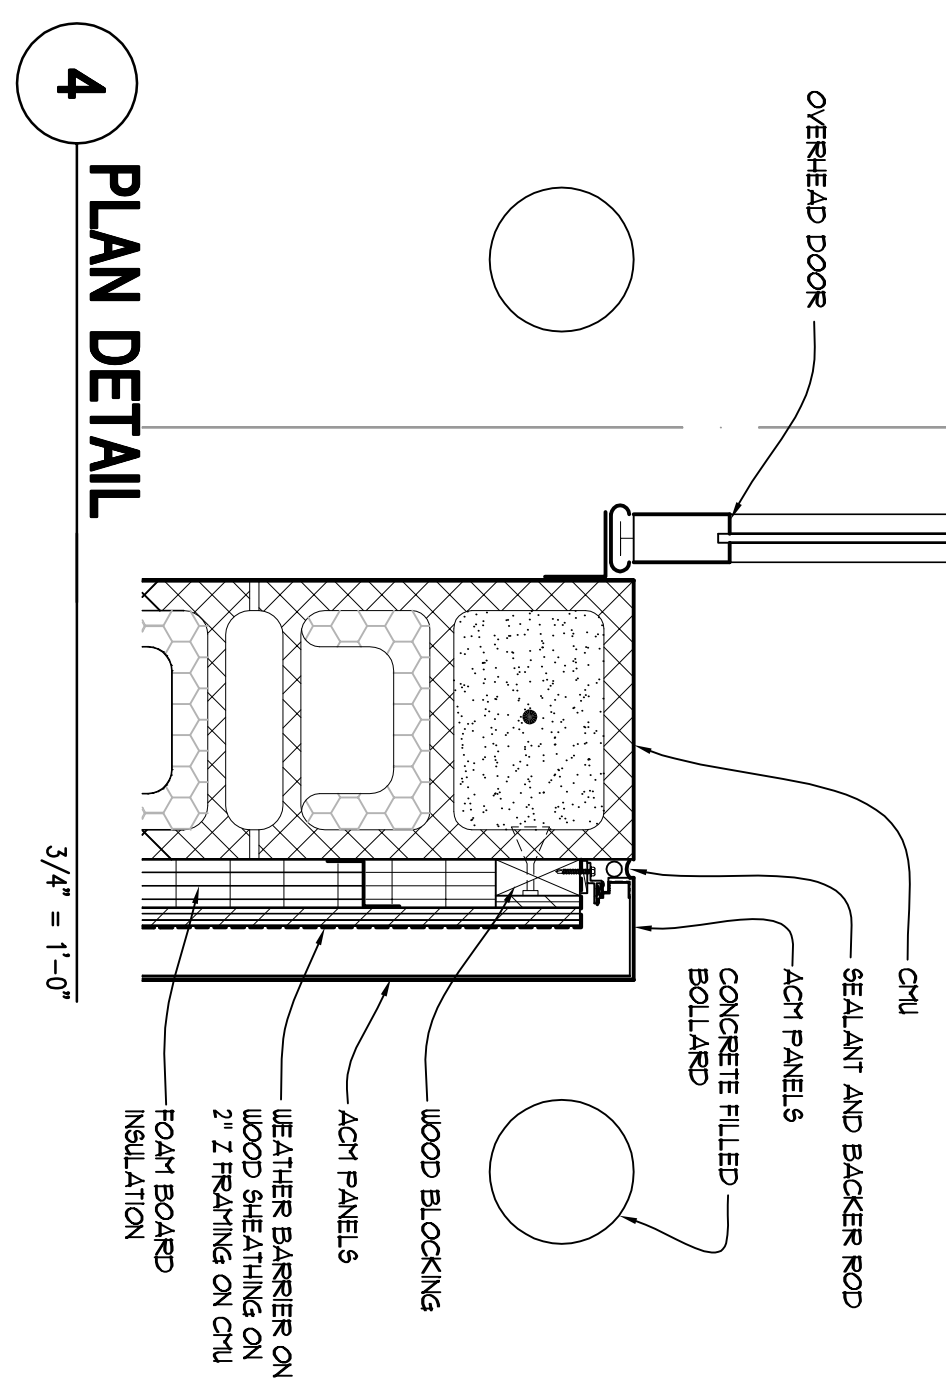


4 PLAN DETAIL
3/4" = 1'-0"

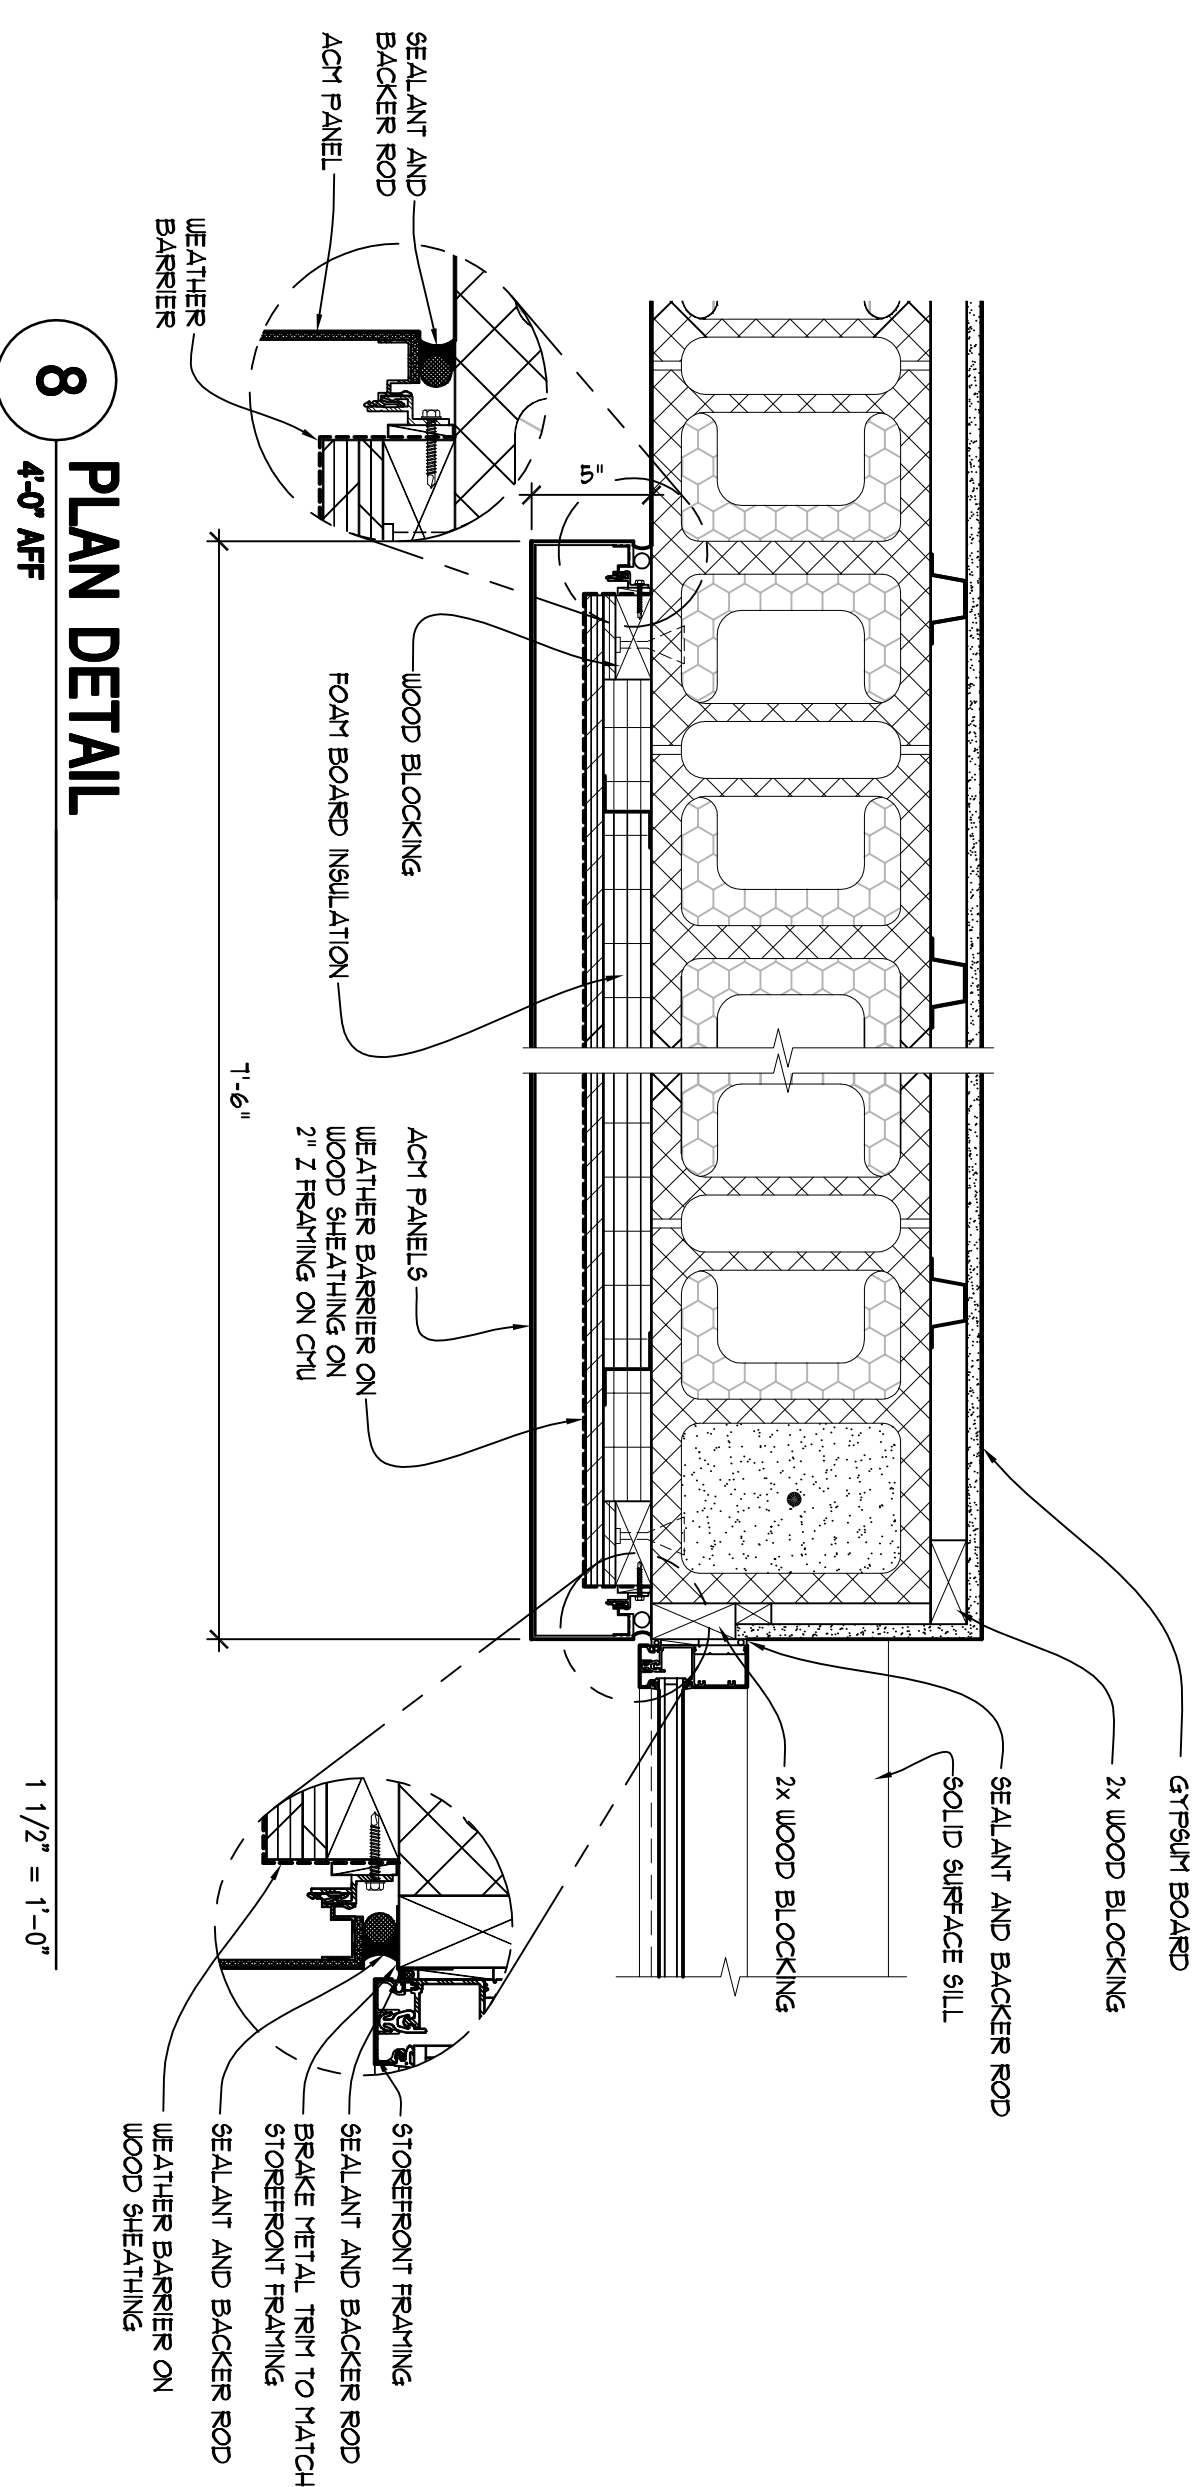

8 PLAN DETAIL
4'-0" AFF
1 1/2" = 1'-0"

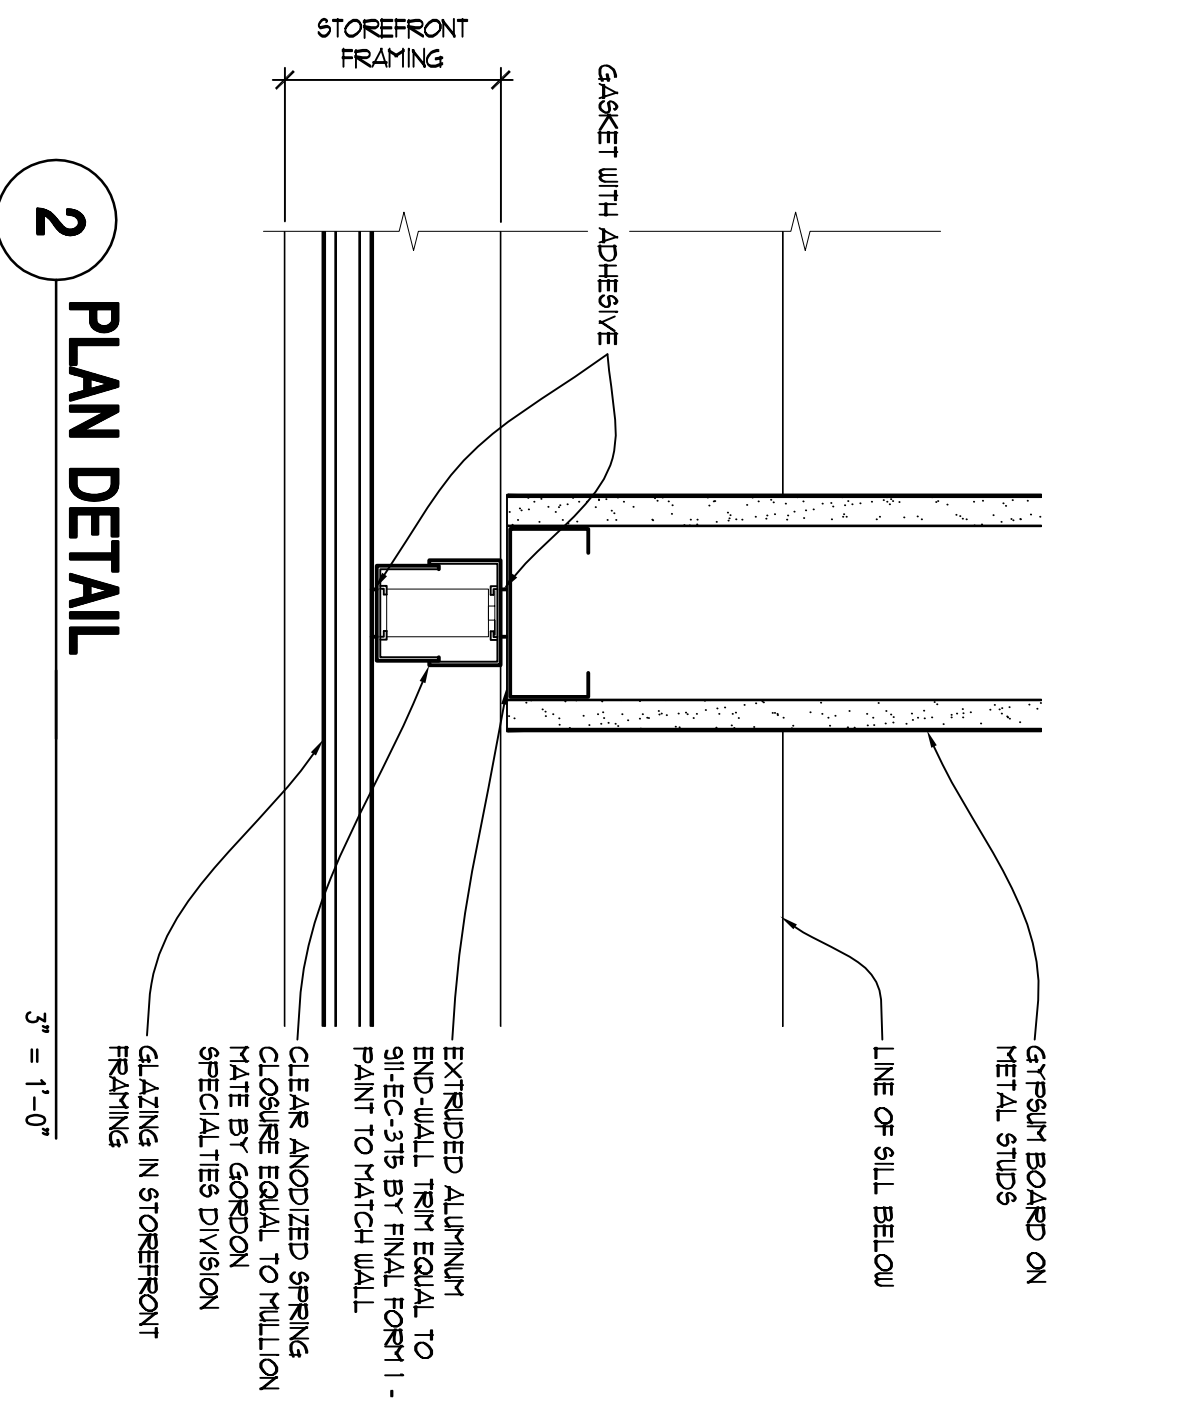


2 PLAN DETAIL
3" = 1'-0"

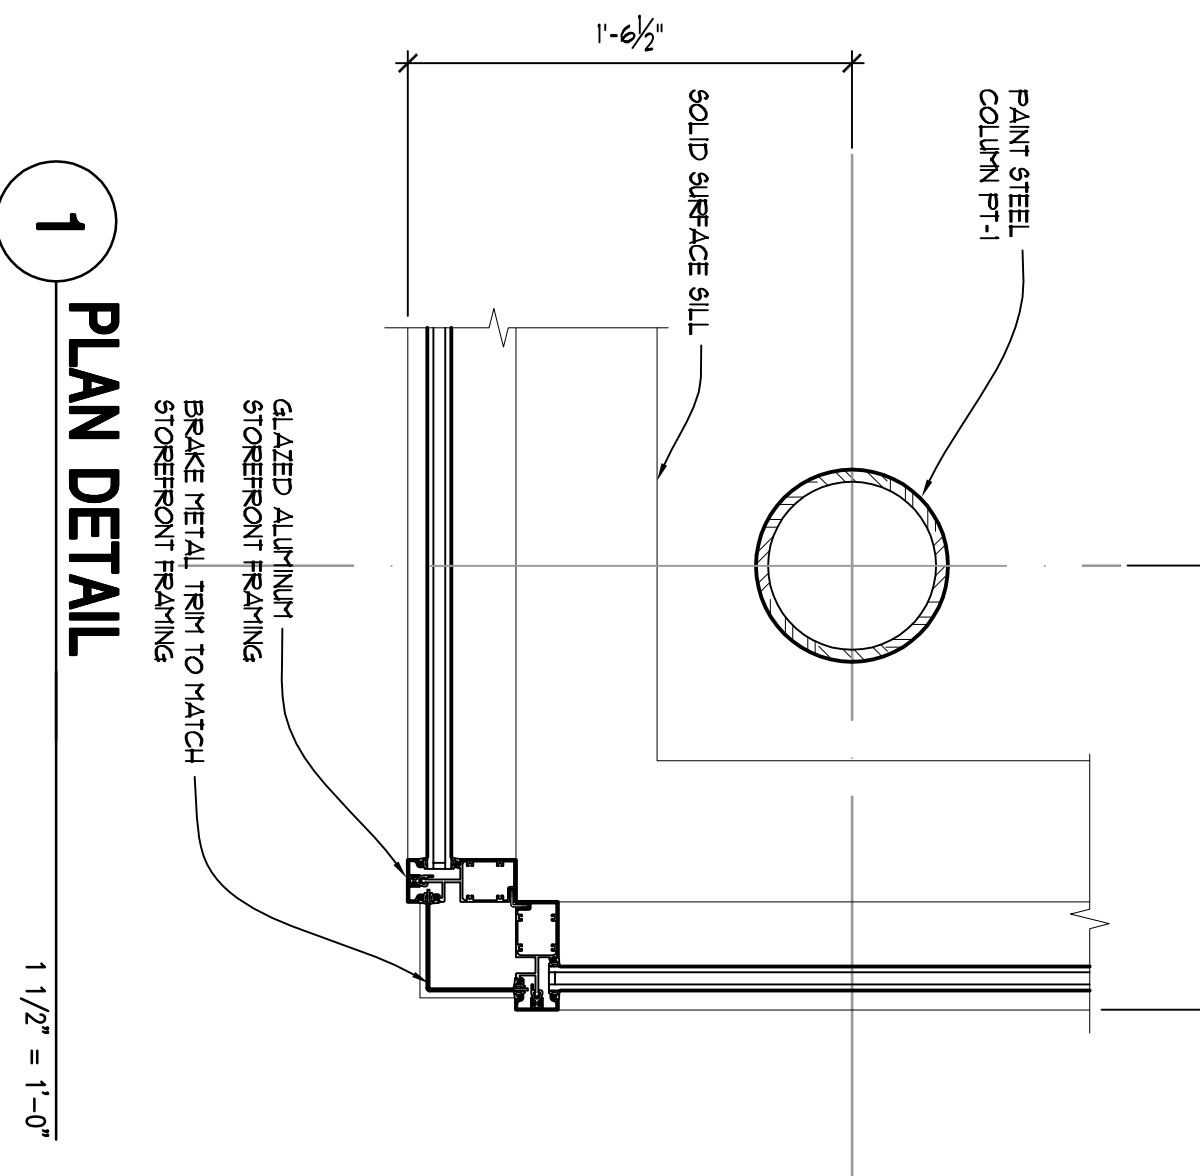

1 PLAN DETAIL
1 1/2" = 1'-0"



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project title

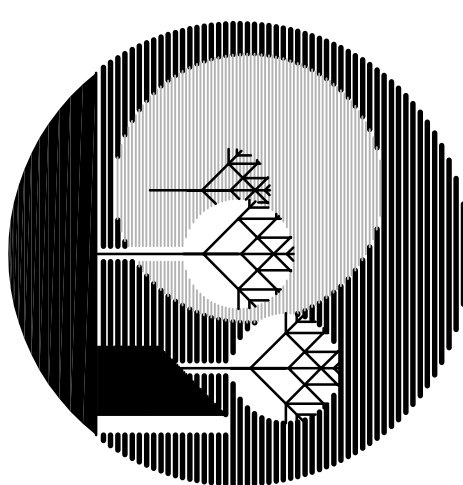
DENMIER QUICKLANE

37410 MICHIGAN AVE
WAYNE, MI

sheet title

DETAILS

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project number

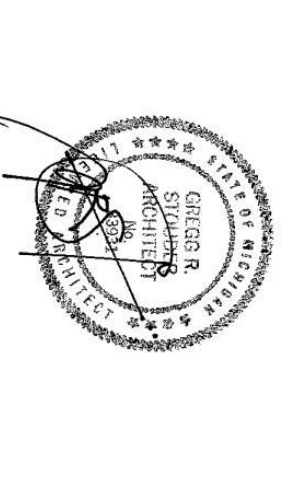13002

drawn	USA
approved	USA
issued	date
BIDS AND PERMITS	12-20-2013
BIDS AND PERMITS	02-07-2014

SHEET

A-501

ARCHITECTURAL SPECIFICATIONS

DIVISION 3 – CONCRETE

CAST-IN-PLACE CONCRETE

1. Provide cast-in-place concrete slabs as described in structural Drawings.

DIVISION 4 – MASONRY

CONCRETE MASONRY

CONCRETE MASONRY UNITS

1. Provide units complying with ASTM C90.
2. Regular Units: Standard hollow units.
 - 2.1. Size: Nominal 8" x 16" x thickness noted on Drawings.
 - 2.2. Provide special shapes (jamb blocks, corners, bond beams, etc.) as required by layout.
 - 2.3. Factory-installed insulation inserts at exterior CMU.

Decorative Units: Benchmark burnished units by Grand Blanc

Cement Products:

- 3.1. Colors: As noted on elevations.
- 3.2. Provide special shapes (jamb blocks, corners, bond beams, etc.) as required by layout.
- 3.3. Factory-installed insulation inserts.

4. Decorative Units: Benchmark burnished units by Grand Blanc

Cement Products:

- 4.1. Colors: As noted on elevations.
- 4.2. Sealant: One coat factory-applied sealant.
- 4.3. Provide special shapes (jamb blocks, corners, bond beams, etc.) as required by layout.
- 4.4. Factory-installed insulation inserts.

REINFORCING

1. Provide vertical and horizontal reinforcing as indicated on structural Drawings.

MORTAR AND GROUT

1. Mortar Mix: ASTM C 270, Proportion Specification.
 - 1.1. Type M or S for masonry below grade or in contact with earth.
 - 1.2. Type S for unreinforced masonry.
 - 1.3. Type S for reinforced masonry.

2. Standard Grout Mix: ASTM C 476, slump of 8 to 11 inches

measured per ASTM C 143.

3. Water: Potable, clean and free of deleterious materials.

INSULATION

1. Unshopped expanded polystyrene inserts equal to KORFL Block Insulation by Concrete Block Insulating Systems, Inc.
2. Install insulation inserts in block cores at CMU plant.

PREFORMED DRAINAGE SYSTEM

1. Provide system equal to BlockFlash by Mortar Net Solutions.
 - 1.1. High density polypropylene pan with perimeter flange and weep spout.
 - 1.2. Integrated web spacer/bridge unit.
 - 1.3. Open weave polyester mesh drainage mat installed in each CMU cell above the pan.

INSTALLATION

1. Use decorative units where exterior masonry will be exposed in final construction.
2. Place masonry units in running bond pattern unless otherwise noted.
3. Tool mortar joints to a concave profile on interior face of wall when mortar is thumbprint hard.
4. Mortar bed joints on CMU cross webs where individual CMU cells are to be grouted.
5. Install reinforcing as indicated on structural Drawings.
6. Breach of masonry walls shall meet the requirements of MIOSHA Construction Safety Standards, Part 2.
7. Installation of Preformed Drainage System: Comply with manufacturer's written instructions.
8. Cover tops of CMU walls at completion of each day's work as practicable as possible. Covering shall remain to minimize water and debris intrusion of ungrouted cells until permanent closure of walls occurs.
9. After final cleaning of exterior CMU walls, apply one seal coat to decorative exterior masonry as recommended by manufacturer of burnished block.

CAST STONE

1. Provide cast stone units complying with ASTM C 1364 by one of the following manufacturers:
 - 1.1. Custom Stone Works
 - 1.2. Royal Stone
 - 1.3. Superior Precast Products
2. Shapes: As indicated on Drawings.
3. Color: As selected by Owner
4. Set units in full bed of mortar with full head joints. Build anchors and ties into mortar joints as units are set.

DIVISION 5 – METALS

STRUCTURAL STEEL FRAMING

STEEL JOIST FRAMING

METAL DECKING

COLD-FORMED METAL FRAMING

1. Provide structural steel framing, steel joist framing, metal decking, and cold-formed metal framing as identified on structural Drawings.
2. Provide submittals for structural steel framing, steel joist framing, metal decking, and cold-formed metal framing as identified on structural Drawings

METAL LADDERS

3. Prefabricated aluminum ladder equal to O'Keefe's Standard Duty Channel Rail Model 500
- 3.1. Mill Finish

DIVISION 6 – WOOD AND PLASTICS

ROUGH CARPENTRY

1. Sheathing: Provide 3/4 inch fire-retardant treated exterior plywood.
2. Wood Blocking: As indicated on Drawings.

3. Weather Barrier Sheet

- 3.1. Non-woven, non-perforated weather barrier sheet designed for mechanical fastening. Provide one of the following:
 - 3.1.1. R-Wrap Protective House Wrap by Barricade Building Products
 - 3.1.2. Tyvek Commercial/Wrap by DuPont

3.2. Accessory Materials

- 3.2.1. Seam Tape: Pressure-sensitive plastic tape recommended by building wrap manufacturer for sealing joints and penetrations in building wrap.
- 3.2.2. Fasteners: As recommended in writing by membrane manufacturer for each substrate.

4. Flexible Flashing: Composite, self-adhesive, flashing product

- consisting of a pliable, butyl rubber or rubberized-asphalt compound, bonded to a high-density polyethylene film, aluminum foil, or spunbonded polyolefin to produce an overall thickness of not less than 0.030 inch. Provide GreenGuard Flashing by Pacific Building Products or a comparable product by one of the following:
 - 4.1. Grace Construction Products, a unit of W. R. Grace & Co.
 - 4.2. DuPont (E. I. du Pont de Nemours and Company)

ARCHITECTURAL WOODWORK

PLASTIC LAMINATE CABINETS

1. Quality Standard: AWI Custom Grade, flush overlay construction.
2. Laminate Cladding for Exposed Surfaces: HGS; color as indicated on Drawings.
3. Materials for semilexposed Surfaces: Thermoset decorative overlay.

PLASTIC LAMINATE COUNTERTOPS, BACKSPLASHES, SIDESPLASHES

1. Quality Standard: AWI Custom Grade.
2. Laminate Cladding for Exposed Surfaces: HGS; color as indicated on Drawings.
3. Edge Treatment: Same cladding as horizontal surfaces.

4. Core Material:

- 4.1. At Counters without Sinks: Particleboard or medium-density fiberboard.
- 4.2. At Counters with Sinks: Particleboard made with exterior glue, medium-density fiberboard made with exterior glue, or exterior-grade plywood

CABINET HARDWARE AND ACCESSORIES

1. Hinges: Frameless concealed
2. Pulls: Wire pulls
3. Drawer Slides: Side-mounted, full extension

SOLID SURFACE MATERIAL

1. Solid-Surfacing Material: Homogeneous solid sheets or filled plastic resin equal to Corian.
2. Sheet Thickness: 1/2 inch.
3. Color: Gray as selected by Owner.

INSTALLATION

1. Coordinate blocking for wall supported cabinets, panels, and trim mounted on the wall.
2. Cabinets: Install without distortion so doors and drawers fit openings properly and are accurately aligned. Adjust hardware to center doors and drawers in openings and to provide unencumbered operation.
3. Countertops: Anchor securely by screwing through corner blocks of base cabinets or other supports into underside of countertop.
4. Secure backsplashes and sidesplashes to tops with concealed metal brackets at 16 inches o.c. and to walls with adhesive.
5. Caulk space between backsplash and wall with sealant.

DIVISION 7 – THERMAL AND MOISTURE PROTECTION

INSULATION

1. Refer to Masonry specification for masonry cell insulation
2. Refer to EPDM Roofing specification for roofing insulation
3. Thermal Batt Insulation: Fiberglass blanket insulation with foil vapor barrier; R-value as noted on Drawings.
4. Foam Board Insulation

4.1. Foundation Insulation: 2 inch thick extruded polystyrene board.

4.1.1. Water Absorption: ≤ 0.3% (ASTM C272)

4.2. Wall-Turning Insulation: 2 inch thick extruded polystyrene board.

5. Acoustical Batt Insulation: Unfaced slag-wool / rock-wool-fiber blanket; match stud thickness.

6. Auxiliary Materials: Vapor retarder tape as recommended by insulation manufacturer.

7. Install all insulation per manufacturer's recommendations.

CORRUGATED METAL WALL PANELS

MATERIALS

1. Corrugated aluminum wall panels with exposed fasteners.
2. Color and Profile: As indicated on exterior elevation Drawings.

3. Miscellaneous Materials:

- 3.1. Trim: Trim shall be fabricated of the same material and finish to match the panels.
- 3.2. Closers: Provide preformed polyethylene to match the panel profile.
- 3.3. Fasteners: Provide fasteners of type, material, size, corrosion resistance, holding power and other properties required to fasten panels to substrates.

INSTALLATION

1. Install metal panels over weather barrier on wood sheathing.
2. Remove strippable film immediately before or after panel installation, as recommended by panel manufacturer.
3. Install manufacturer's standard edge trim as indicated on Drawings and as recommended by manufacturer.

ALUMINUM COMPOSITE METAL PANELS

MATERIALS

1. Panels: Face sheets of aluminum and thermoplastic core.
 - 1.1. Manufacturer and Color: As indicated on Drawings.
 - 1.2. Thickness: 4 mm
2. Fasteners: Concealed and non-corrosive fasteners as recommended by panel manufacturer.

FABRICATION

1. Provide a rain screen system equal to Sobotec dry joint SL-2000 with 1/2 inch wide panel joints.
2. Provide panel clips, stiffeners, anchor channels and all other hardware recommended by panel manufacturer and fabricator.

INSTALLATION

1. Install metal panels over weather barrier on wood sheathing.
2. Remove strippable film immediately before or after panel installation, as recommended by panel manufacturer.
3. Install manufacturer's standard edge trim as indicated on Drawings and as recommended by manufacturer.

EPDM ROOFING

1. Mechanically fastened ethylene-propylene-diene-monomer (EPDM) roofing system.
2. Special Warranty: Manufacturer agrees to repair or replace components of roofing system that fail in materials or workmanship within specified warranty period.

3. Warranty Period: 15 year from date of Substantial Completion.

4. EPDM Membrane: 60 mil EPDM Block, as recommended by manufacturer for mechanically fastened system.

5. Insulation: 5.1. Performed roof insulation boards manufactured or approved by EPDM manufacturer.

5.1.1. R-value: R32

5.2. Polysycynurate Board Insulation: ASTM C 1289, Type II, Class 1, Grade 2, felt or glass-fiber-mat facer on both major surfaces.

5.3. Tapered Insulation: Provide factory-tapered insulation boards at locations shown on Drawings.

6. Flexible Walkways: Factory-formed, nonporous, heavy duty, solid rubber, slip-resisting, surfaced-textured walkway pods, approximately 3/16 inch thick and acceptable to roofing system manufacturer.

7. Install according to manufacturer's written instructions. Arrange for inspection by roofing system manufacturer.

SHEET METAL FLASHING AND TRIM

MATERIALS

1. Factory-Printed Aluminum Sheet: ASTM B 209, 3003-H14, with a minimum thickness of 0.040 inch, unless otherwise indicated.
 - 1.1. Finish: Fluoropolymer 2-Coat Coating System: Manufacturer's standard 2-coat, thermocured system composed of specially formulated inhibitive primer and fluoropolymer color topcoat containing not less than 70 percent polyvinylidene fluoride resin by weight; complying with AAMA 605.2.
2. Fasteners: Some metal as sheet metal flashing or other noncorrosive metal as recommended by sheet metal manufacturer. Match finish of exposed heads with material being fastened.
3. Mastic Sealant: Polyisobutylene; nonhardening, nonskinning, nonshrinking, nonmigrating sealant.
4. Metal Accessories: Provide sheet metal clips, straps, anchoring devices, and similar accessory units as required for installation of work, matching or compatible with material being installed; noncorrosive; size and thickness required for performance.

FABRICATION

1. Expansion Provisions: Space movement joints at maximum of 10 feet with no joints allowed within 24 inches of corner or intersection.

2. Fabricate cleats and attachment devices from same material as sheet metal component being anchored or from compatible, noncorrosive metal recommended by sheet metal manufacturer.

3. Size: As recommended by SMACNA manual or sheet metal being secured.

INSTALLATION

1. Expansion Provisions: Space movement joints at maximum of 10 feet with no joints allowed within 24 inches of corner or intersection.

2. Fabricate cleats and attachment devices from same material as sheet metal component being anchored or from compatible, noncorrosive metal recommended by sheet metal manufacturer.

3. Size: As recommended by SMACNA manual or sheet metal being secured.

INSTALLATION

1. Expansion Provisions: Space movement joints at maximum of 10 feet with no joints allowed within 24 inches of corner or intersection.
2. Fabricate cleats and attachment devices from same material as sheet metal component being anchored or from compatible, noncorrosive metal recommended by sheet metal manufacturer.
3. Size: As recommended by SMACNA manual or sheet metal being secured.

JOINT SEALANTS

LATEX JOINT SEALANTS

1. Acrylic-Emulsion Sealant: Manufacturer's standard one part, non soq, mildew-resistant, acrylic-emulsion sealant complying with ASTM C 834, formulated to be paintable and recommended for exposed applications on interior.
2. Products: Provide one of the following
 - 2.1. AC-20 by Pecora Corporation.
 - 2.2. Sonolac by Sonneborn Building Products Division.
 - 2.3. Tremco Acrylic Latex 834 by Tremco Inc.
3. Use for:
 - 3.1. Exposed interior wall joints.
 - 3.2. Joints between millwork and adjacent construction.

ELASTOMERIC SEALANTS


1. Silicone Sealant: One part silicone sealant complying with ASTM C 290, Type S, Grade NS, Class 25; Use W, G, A, O.
2. Products: Provide one of the following
 - 2.1. Dow Corning 790.
 - 2.2. General Electric Ultragloze 4200.
3. Use for joints between aluminum and masonry and metal.

URETHANE SEALANTS

1. Multi-part nongrsg urethane sealant complying with ASTM C 920, Type M, Grade NS; Class 25; Use T.
2. Products: Provide one of the following
 - 2.1. Vulken 922 by Mamco Corporation.
 - 2.2. Dynatred by Pecora Corporation.
 - 2.3. Permapiol RC-270 by Products Research & Chemical Corporation.
 - 2.4. Silkaflex 2C NS by Silka Corporation.
 - 2.5. Sonolastic NP2 by Sonneborn Building Products Division.
3. Use for flooring joints subject to traffic.



pre p a r e d b y :

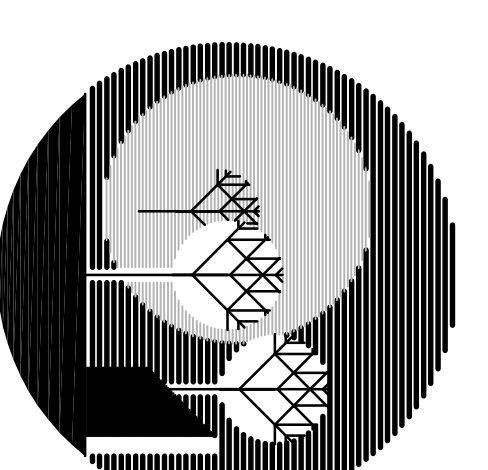

UNDER THE SUN
ARCHITECTURAL LLC

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n o t i c e

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UNDER THE SUN, LLC
CORPORATE, YEAR 2019

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QUICKLANE


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s h e e t t i t l e

ARCHITECTURAL
SPECIFICATIONS

DO NOT SCALE DIMENSIONS
USE FINISHED DIMENSIONS ONLY

s e a l & s i g n a t u r e

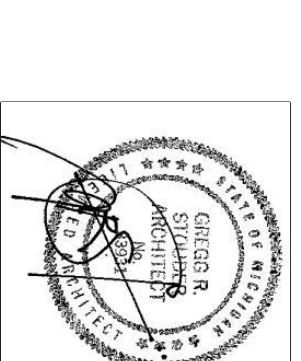

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